

Luke Perry

Project Manager

411 University Ridge, Suite D

#### APPLICATION FOR MULTIFAMILY DEVELOPMENT

**APPLICANT** 

Contact Planning & Development (864) 467-4476

Office Use Only: Application#	Fees Paid
Date Received	Accepted By
Date Complete	App Deny Conditions

PROPERTY OWNER

Soteria CDC

Owner

201 Shaw St.

#### **APPLICANT/OWNER INFORMATION**

#### \*Indicates Required Field

\*Name:

\*Title:

*Address:	411 University Ridge, Suite D	201 Shaw St.
*State:	SC	SC
*Zip:	29601	29609
*Phone:	864-250-0701	864-271-8227
*Email:	luke@johnstondesigngroup.us	jblassingame@soteriacdc.org
	PROPERTY INFORI	MATION_
*STREET AD	DDRESS 301 Shaw St.	
*TAX MAP #	0150001301200	
*CURRENT 2	ZONING DESIGNATION RM-2	
*TOTAL ACR	REAGE 0.26 Acres	
	PROPOSED DEVELOPMEN	T INFORMATION
*TYPE OF AI	PPLICATION: X NewModification – Ma	jorModification – Minor
*ORIGINAL A	APPLICATION # (put N/A if new application)N/A	
*NUMBER O	F UNITS 5	
*MULTIFAMI	LY DEVELOPMENT TYPE Rental Apartments	
*AGE RESTF	RICTED HOUSING (Y / N)N	
NUMBER OF	UNITS AND/OR PERCENTAGE OF AGE RESTRICT	ED UNITS (If applicable)
	INSTRUCTION	<u>NS</u>
	licant is <b>required</b> to schedule a pre-application me . Call (864) 467-4476 to schedule an appointment.	eeting according to the dates outlined on the Board
	*PREAPPLICATION MEETING DATE12	2/8/21
	olication includes more than one (1) parcel and/or mo	re than one (1) owner, the applicant must provide the address owner signatures as an attachment.

3. All applications and fees (made payable to the City of Greenville) for designation as a Multifamily Development must

be received by no later than 2:00 pm of the date reflected on the Board schedule.

	B. Multifamily development – Major	Modification	\$275.00 – public hearing required
	C. Multifamily development – Minor	Modification	\$150.00 – administrative review
4.	application is deemed insufficient, staf	f will notify the applicant and requents. In this event, the item will of	.2.6, Determination of Sufficiency. If the uest that the application be revised and go back into the queue for review. Please ditional information.
5.	<b>Public Notice Requirements.</b> Multifam There is also an informal review from the		re a Planning Commission public hearing. or to the planning commission hearing.
6.	The applicant is responsible for sign submission.	posting the subject property. Ins	tructions will be provided at the time of
7.	eight (8) days prior to the scheduled	Planning Commission hearing (	rhood meeting which is to be held <u>at least</u> Sec. 19-2.2.4, Neighborhood meetings). Dicant email provided on page one of this
8.	Upon planning commission recommend	ation, the application item will be so	heduled for city council hearing.
	To be filled out at time of application	<u>submittal</u>	
	X Public Hearing signs	are acknowledged as received by	the applicant
		ons and affidavit are acknowledged	
	*APPLICANT SIGNATURE Luks	Perry	
9.		on is reflected on the plan(s), and	submit one (1) paper copy and one (1)
10.			nformation submitted with this application; f their knowledge and they have provided
		a deed or other document places or	on the applicant's behalf has made a ne or more restrictions on the property that triction.
	applicant does not withdraw or modify the waived, then the planning office will in change would not likely result in the benefit of the planning of the planni	ne application in a timely manner, of dicate in its report to the planning efit the applicant seeks.	exists, it shall notify the applicant. If the or act to have the restriction terminated or commission that granting the requested
	Lu	ke Perry *APPLICA	NT ACKNOWLEDGEMENT SIGNATURE
	01/18/20	22	
11.		or <b>is not</b> _x restricted by ar	by affirms that the tract or parcel of land by recorded covenant that is contrary to,
	*Signatures		
	*Applicant	Luke Perry	
		1/18/2022	
	*Date	Jerry Blassingame	
	*Property Owner/Authorized Agent	Jerry Custinguite	
	*Date	1/18/2022	


\$550.00 – public hearing required


A. Multifamily development - New


#### **APPLICATION REQUIREMENTS**

- 1. Multifamily development format and content requirements are reflected in the City of Greenville Administrative Manual at Appendix 'H'.
- 2. The submitted information shall include at a minimum:
  - a. Completed application for Multifamily development;
  - b. Context map, showing relationship of proposed development to the surrounding neighborhood;
  - c. Photographs of surrounding area;
  - d. Site plan, showing building(s) footprint, parking lot layout, pedestrian and vehicular access, internal walkways, amenities (i.e. pool, playground, picnic area, etc.), and service areas (i.e. dumpster pad/trash collection area, HVAC units, car wash area, etc.);
  - e. Grading plan, showing existing and proposed topographic contours, storm drainage collection facilities, existing and proposed retaining walls (with top-of-wall and bottom-of-wall elevations for at least the ends of the walls and the high point of the walls);
  - f. Building elevations, of all sides of the building(s), with exterior materials and colors indicated;
  - g. Plan showing elevation of proposed buildings in relation to adjoining structures;
  - h. Building floor plans;
  - i. Landscape plan, showing existing vegetation that will remain and the new plants to be added;
  - *j.* Lighting plan, showing location of light fixtures (on the site and on the building), cut sheets of the proposed light fixtures, and wattage; and
  - k. Materials board.
- 3. Please refer to **Section 19-6.8, Design standards for multifamily residential development** for additional information.

#### **MD-22-57 • 301 SHAW STREET**

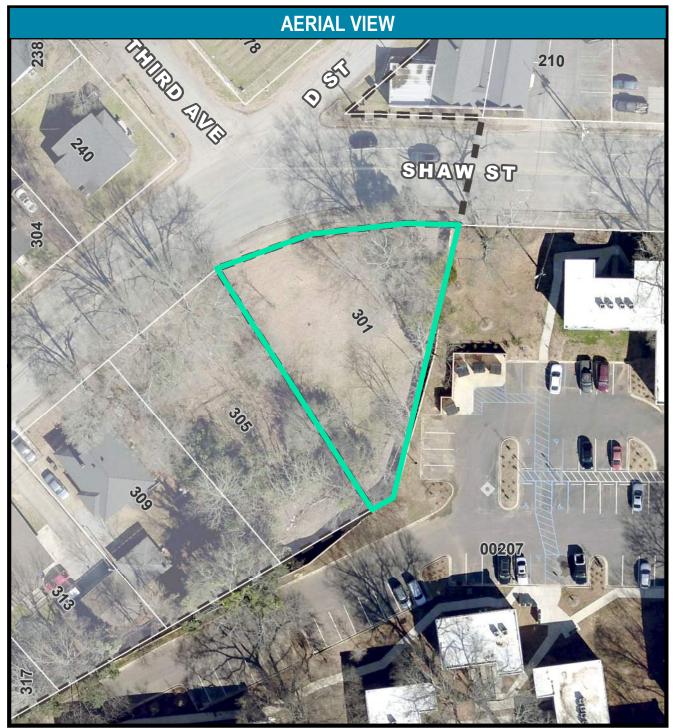

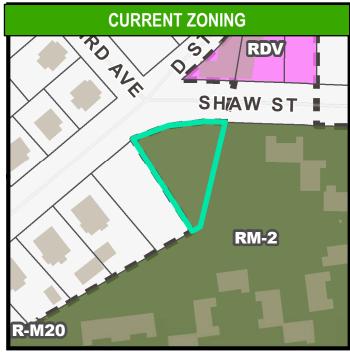


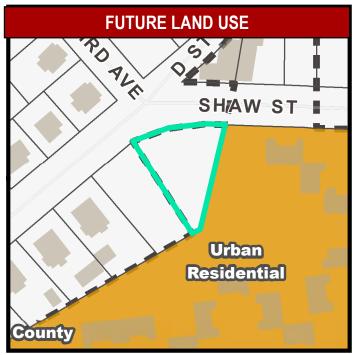

#### **MD-22-57 • 301 SHAW STREET**





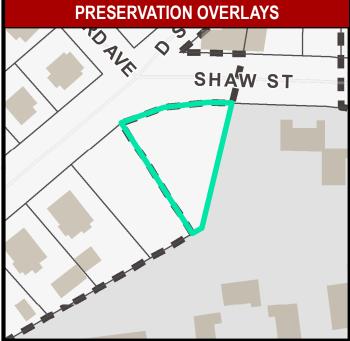





301 SHAW ST. GREENVILLE, SC

JOHNSTON DESIGN GROUP, LLC Suite D 411 UNIVERSITY RIDGE Greenville, SC 29601 ph: 864.250.0701

johnstondesigngroup.us

## FOR REVIEW ONLY

Re	Revisions:							
no.	date	by	checked	description				

Commission: 219016 Date: 1/18/22 Drawn By: xxx Checked By:xxx

COVER SHEET &
PROJECT DATA

G1.01



301 SHAW ST. GREENVILLE, SC

JOHNSTON DESIGN GROUP, LLC Suite D 411 UNIVERSITY RIDGE Greenville, SC 29601 ph: 864.250.0701

johnstondesigngroup.us

## FOR REVIEW ONLY

Re	visions	5:		
no.	date	by	checked	description
A	1/18/22			PLANNING SUBMITTAL
į				
i —	L	1	1	

Commission: 219016
Date: 1/18/22
Drawn By: Author
Checked By: Checker

SITE PLAN

A1.00

### PROJECT INFO

ADDRESS:	301 SHAW ST.
PIN #:	0150001301200
PARCEL SIZE:	0.26 ACRES
PROPOSED ZONING:	RM-2 (CITY OF G
# OF UNITS BY RIGHT:	5
PROPOSED # OF UNITS:	5
PROPOSED BLDG SF:	2,200 +/- GSF
# PARK. SPACES REQ'D:	8 (1.5 × 5)
# PARK. SPACES PROVIDED:	5
CONSTRUCTION TYPE:	V-B
NFPA SPRINKLER SYSTEM:	NONE
UNITS TO BE CONDITIONED BY DI	JCTED MINI-SPLITS



301 SHAW ST. GREENVILLE, SC

JOHNSTON DESIGN GROUP, LLC Suite D 411 UNIVERSITY RIDGE Greenville, SC 29601 ph: 864.250.0701

johnstondesigngroup.us

FOR REVIEW ONLY

Re	visions	<b>:</b>		_
no.	date	by	checked	description
A	1/18/22			PLANNING SUBMITTAL
		<u> </u>		

Commission: 219016 Date: 1/18/22 Drawn By: xxx Checked By:xxx

FLOOR PLANS


FRONT FACADE NOTES: 1. TRANSPARENCY

OVERALL SF: 550 SF

OVERALL MIDTH: 40'-8" PORCH MIDTH: 18-10"

GLAZING SF: 110 SF % GLAZING: 20%

2. PORCH SIZE

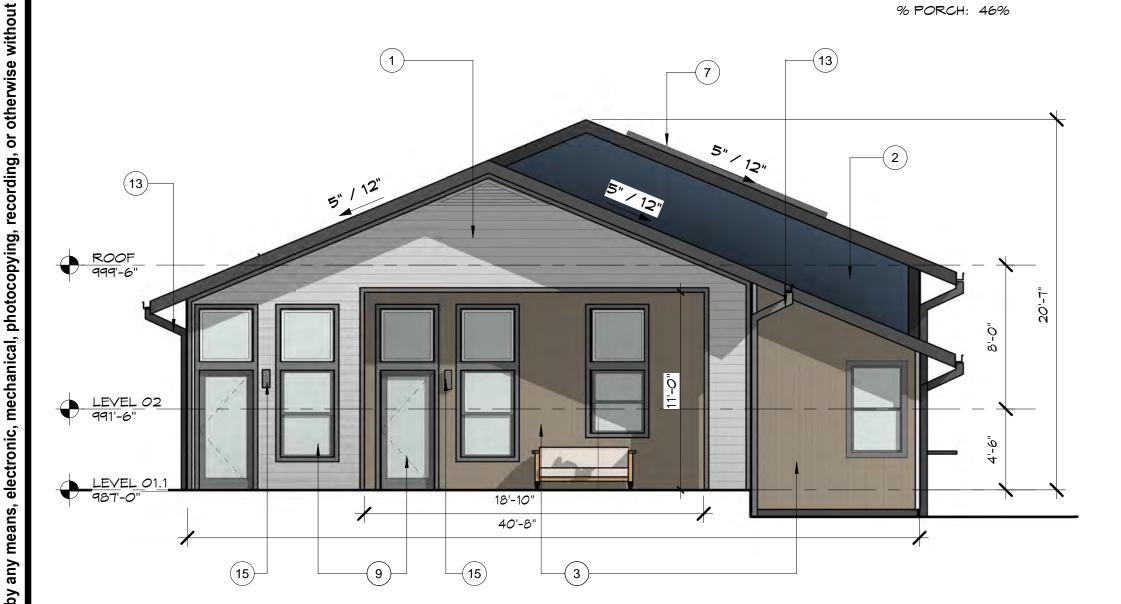

2 NORTH A1.02) 3/16" = 1'-0"







Johnston DESIGN GROUP

EXTERIOR NOTES

FIBER CEMENT LAP SIDING

RECLAIMED WOOD SIDING
ASPHALT SHINGLE ROOF
WOOD DECK/ PATIO
PAINTED METAL RAILING

PV SOLAR PANELS

EXHAUST VENTS

FIBER CEMENT BOARD AND BATTEN

HORIZONTAL SHADING ELEMENT

ALUM. CLAD WINDOWS & DOORS

OPENING IN EXTERIOR WALL

10 SCREEN WALL FOR MECH. EQUIP./ TRASH

SOTERIA

301 SHAW ST. GREENVILLE, SC

JOHNSTON DESIGN GROUP, LLC Suite D 411 UNIVERSITY RIDGE Greenville, SC 29601 ph: 864.250.0701

johnstondesigngroup.us

FOR REVIEW ONLY

Revisions:						
no.	date	by	checked	description		
А	1/18/22			PLANNING SUBMITTAL		

Commission: 219016
Date: 1/18/22
Drawn By: xxx
Checked By:xxx

EXTERIOR ELEVATIONS

# 1STOPLIGHTING The 1 Stop Shop for All Your Lighting Needs



## P560051-30 - Z-1030 LED - Outdoor Light - 1 Light - in Modern style - 5.13 Inches wide by 12 Inches high by Progress Lighting

Family/Collection:	Z-1030
Length:	5.13"
Width/Diameter (in):	5.13"
Height:	12.00"
Depth/Extension:	5.75"
Shade Width at Top (inches):	3.13"
Shade Height (inches):	8.38"
Back Plate Length:	1.00°
Back Plate Width:	4.75"
Overall Length:	5.13W x 5.13L x 12H x 5.75D"
Shade Size:	3,13 x 8,38
Height from Center:	2.25"
Weight:	2.42 lbs
Wire Length:	6,00"
# of Bulbs:	1
Standard Wattage:	9 Watts
Bulb Type:	LED
CRI:	90
Lamp Base Type:	LED Module
Lumens:	333
Color Temperature;	3000 Kelvin
Design Style:	Modern
Shade Feature:	Seeded
Shade Shape:	Diffuser
Voltage Rating:	120 V
Material:	Aluminum
Warranty:	5 Years Limited
Prop 65 Rating:	Yes
Bulbs Included:	Yes
Shade Included:	Yes
Style and Option 1	
Style:	Antique Bronze Finish with Clear/Clear Seeded Glas
Item #:	P560051-020-30
Price:	<del>Reg. \$130.00</del> Save 15% \$110.50
Style and Option 2	
Style:	White Finish with Clear/Clear Seeded Glass
Item #;	P560051-030-30
Price:	Reg: \$130.00 Save 15%
2-12-12-1-1	
Style and Option 3	Black Finish with Clear/Clear Seeded Glass
Style and Option 3 Style:	Diack Fillish With Clear Geeded Glass
	P560051-031-30













*Reg. \$130.00*-Save 15% \$110.50

Metallic Gray Finish with Clear/Clear Seeded Glass





301 SHAW ST. GREENVILLE, SC

JOHNSTON DESIGN GROUP, LLC Suite D 411 UNIVERSITY RIDGE Greenville, SC ph: 864.250.0701

johnstondesigngroup.us

## FOR REVIEW ONLY

no.	date	by	checked	description
Α	1/18/22			PLANNING SUBMITTAL

Commission: 219016
Date: 1/18/22
Drawn By: Author
Checked By: Checker

EXTERIOR MATERIALS

A1.03

### **EXTERIOR MATERIALS & FINISHES** SOTERIA, GREENVILLE SC



PROGRESS EXTERIOR LED WALL SCONCE **BRONZE FINISH** 









GAS DIMENSIONAL ROOF SHINGLES BARKSTONE



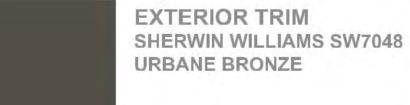



RECLAIMED VERTCAL WOOD SIDING

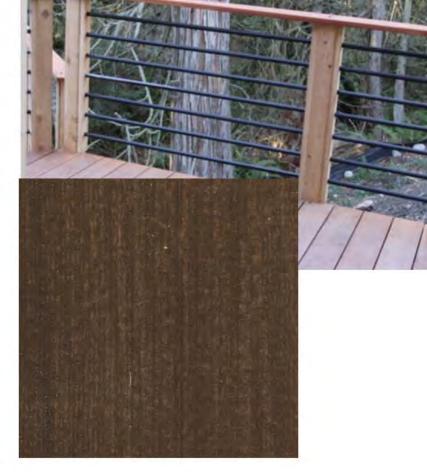

**WOOD & ROD RAIL SYSTEM** CABOT SEMI SOLID STAIN BURNT HICKORY

## Johnston DESIGN GROUP

LAP SIDING

**PASSIVE** 

SHERWIN WILLIAMS SW7064

**BOARD & BATTEN SIDING** SHERWIN WILLIAMS HGSW3341

SPECTRAL INDIGO



ADJACENT SINGLE FAMILY HOUSES TO THE WEST OF THE PROPOSED HOUSING



STRATHAM PLACE APARTMENTS, TO THE EAST OF PROPOSED HOUSING






EXISTING PARCEL AT 301 SHAW ST. LOOKING TOWARDS SOTERIA OFFICES AND STRATHAM PLACE



TYPICAL MILL HOUSING IN POE MILL NEIGHBORHOOD

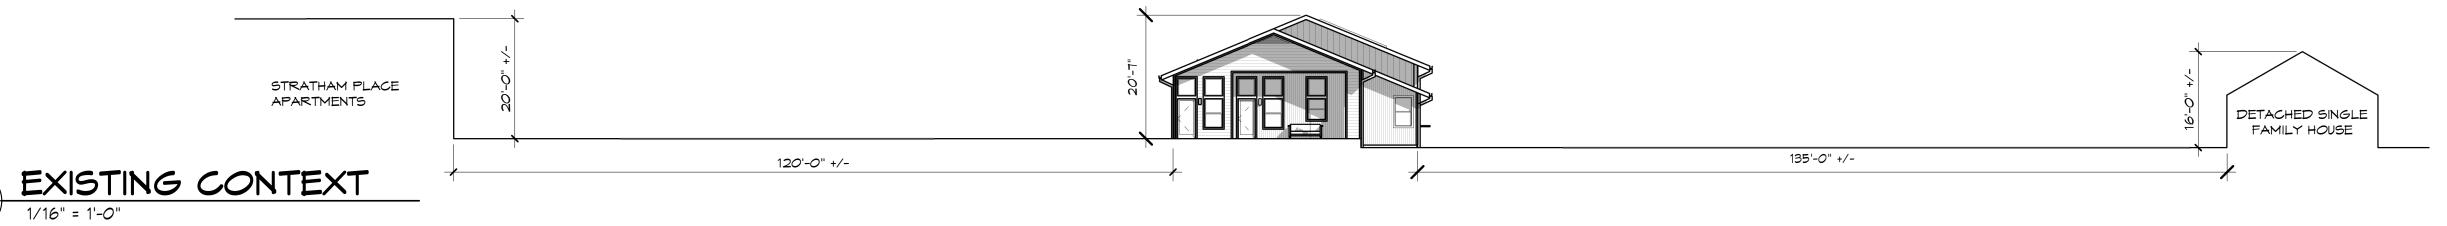



#### 301 SHAW ST. GREENVILLE, SC

#### JOHNSTON DESIGN GROUP, LLC Suite D 411 UNIVERSITY RIDGE Greenville, SC 29601 ph: 864.250.0701

johnstondesigngroup.us

## FOR REVIEW ONLY

10.	date	by	checked	description
Α	1/18/22			PLANNING SUBMITTAL

Commission: 219016
Date: 1/18/22
Drawn By: Author
Checked By: Checker

EXISTING CONDITIONS





301 SHAW ST. GREENVILLE, SC

JOHNSTON DESIGN GROUP, LLC Suite D 411 UNIVERSITY RIDGE Greenville, SC 29601 ph: 864.250.0701

johnstondesigngroup.us


FOR REVIEW ONLY


no.	date	by	checked	description
A	1/18/22			PLANNING SUBMITTAL

Commission: 219016
Date: 1/18/22
Drawn By: Author
Checked By: Checker

3D VIEWS

A1.05

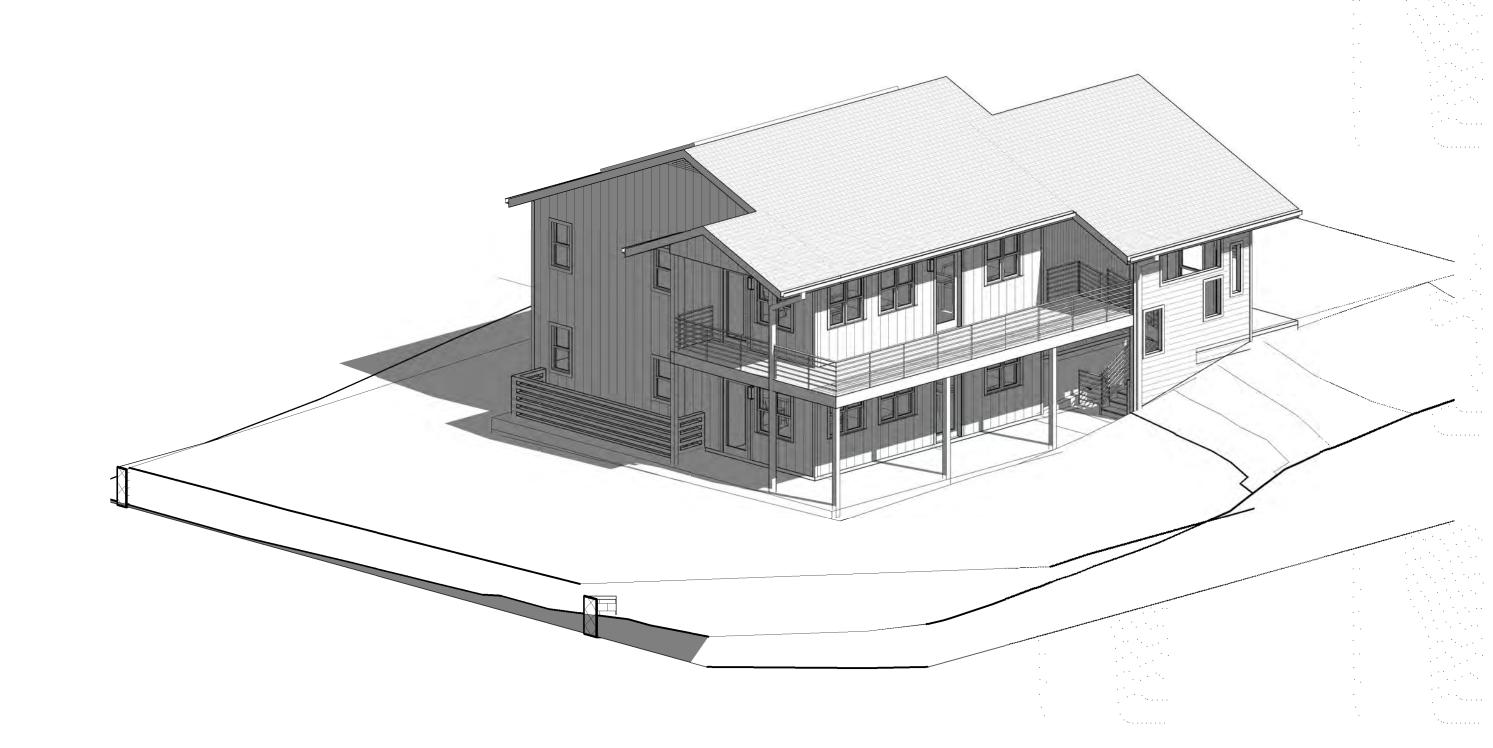

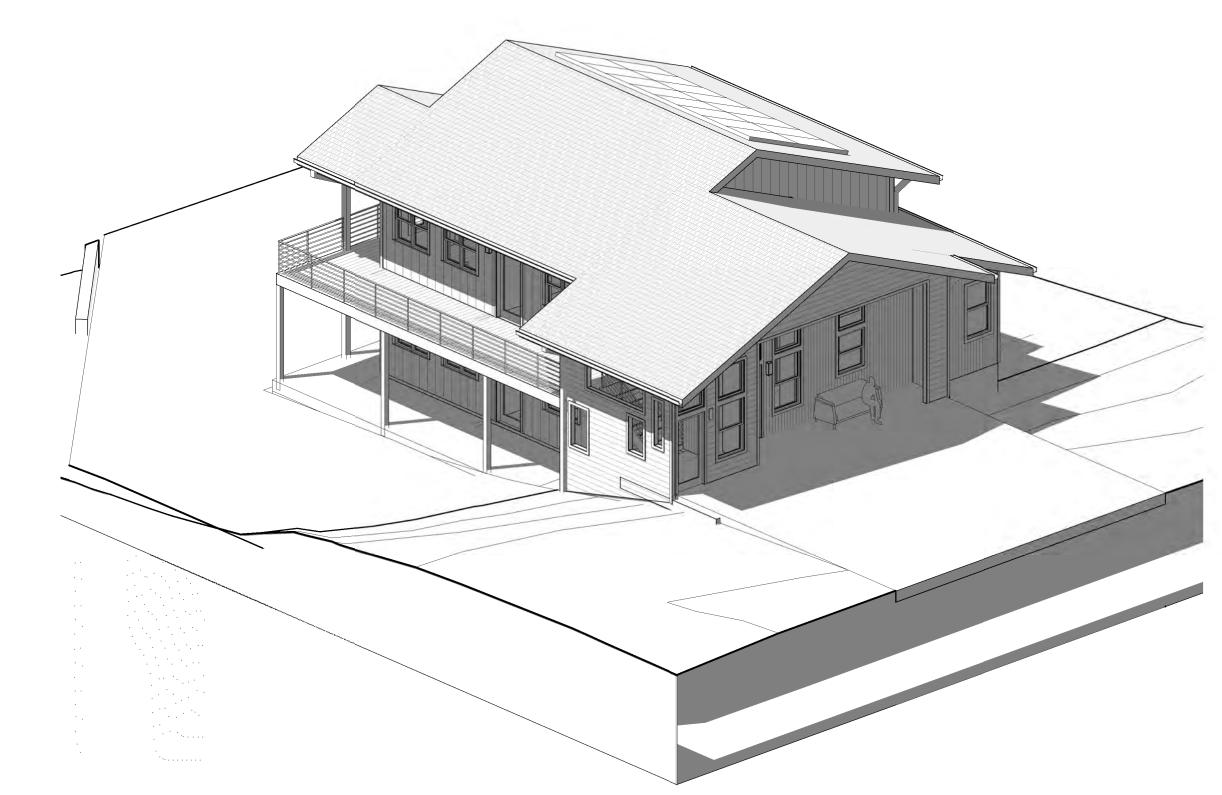








4 3D View 2 A1.05

1 AXON 2-

3 3D View 1 A1.05

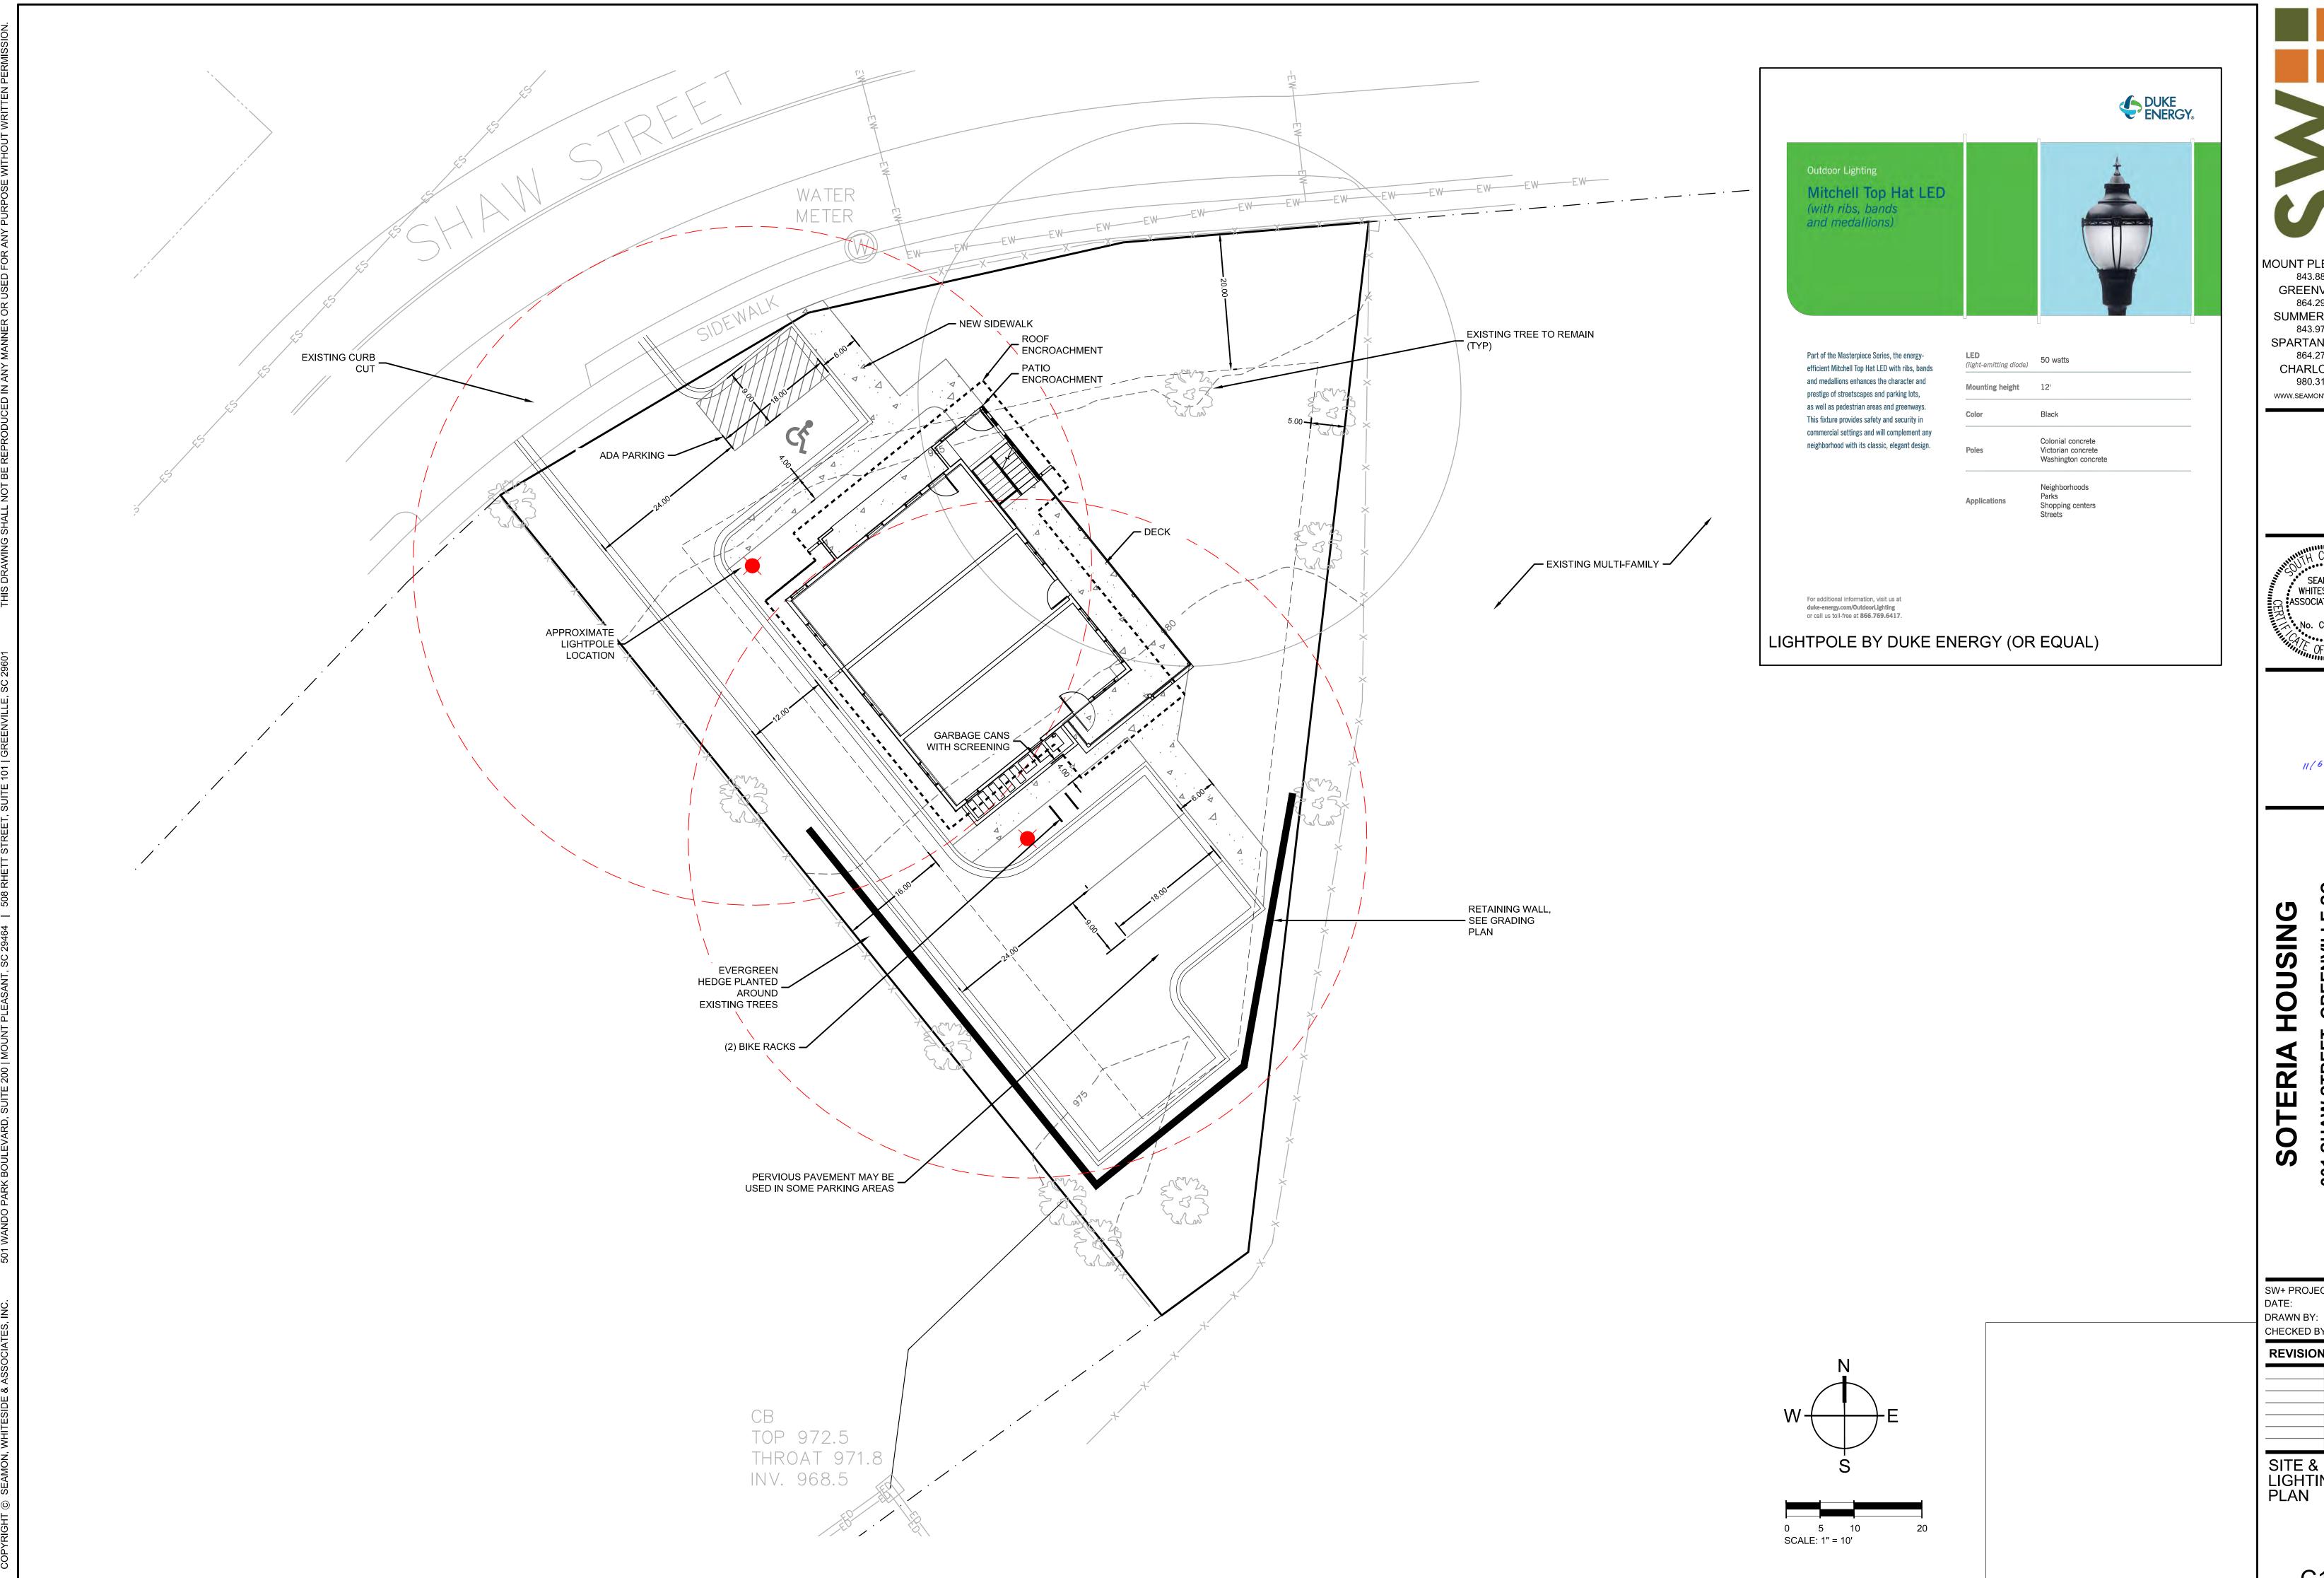

11/6/20

MOUNT PLEASANT, SC 843.884.1667 GREENVILLE, SC 864.298.0534 SUMMERVILLE, SC 843.972.0710 SPARTANBURG, SC 864.272.1272 CHARLOTTE, NC 980.312.5450 WWW.SEAMONWHITESIDE.COM




**REVISION HISTORY** 

SITE & LIGHTING PLAN

C1.0




MOUNT PLEASANT, SC 843.884.1667 GREENVILLE, SC 864.298.0534 SUMMERVILLE, SC 843.972.0710 SPARTANBURG, SC 864.272.1272 CHARLOTTE, NC 980.312.5450 WWW.SEAMONWHITESIDE.COM

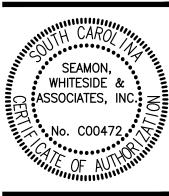

SW+ PROJECT: GR3904
DATE: 01/13/2022
DRAWN BY: DM
CHECKED BY: CG

REVISION HISTORY

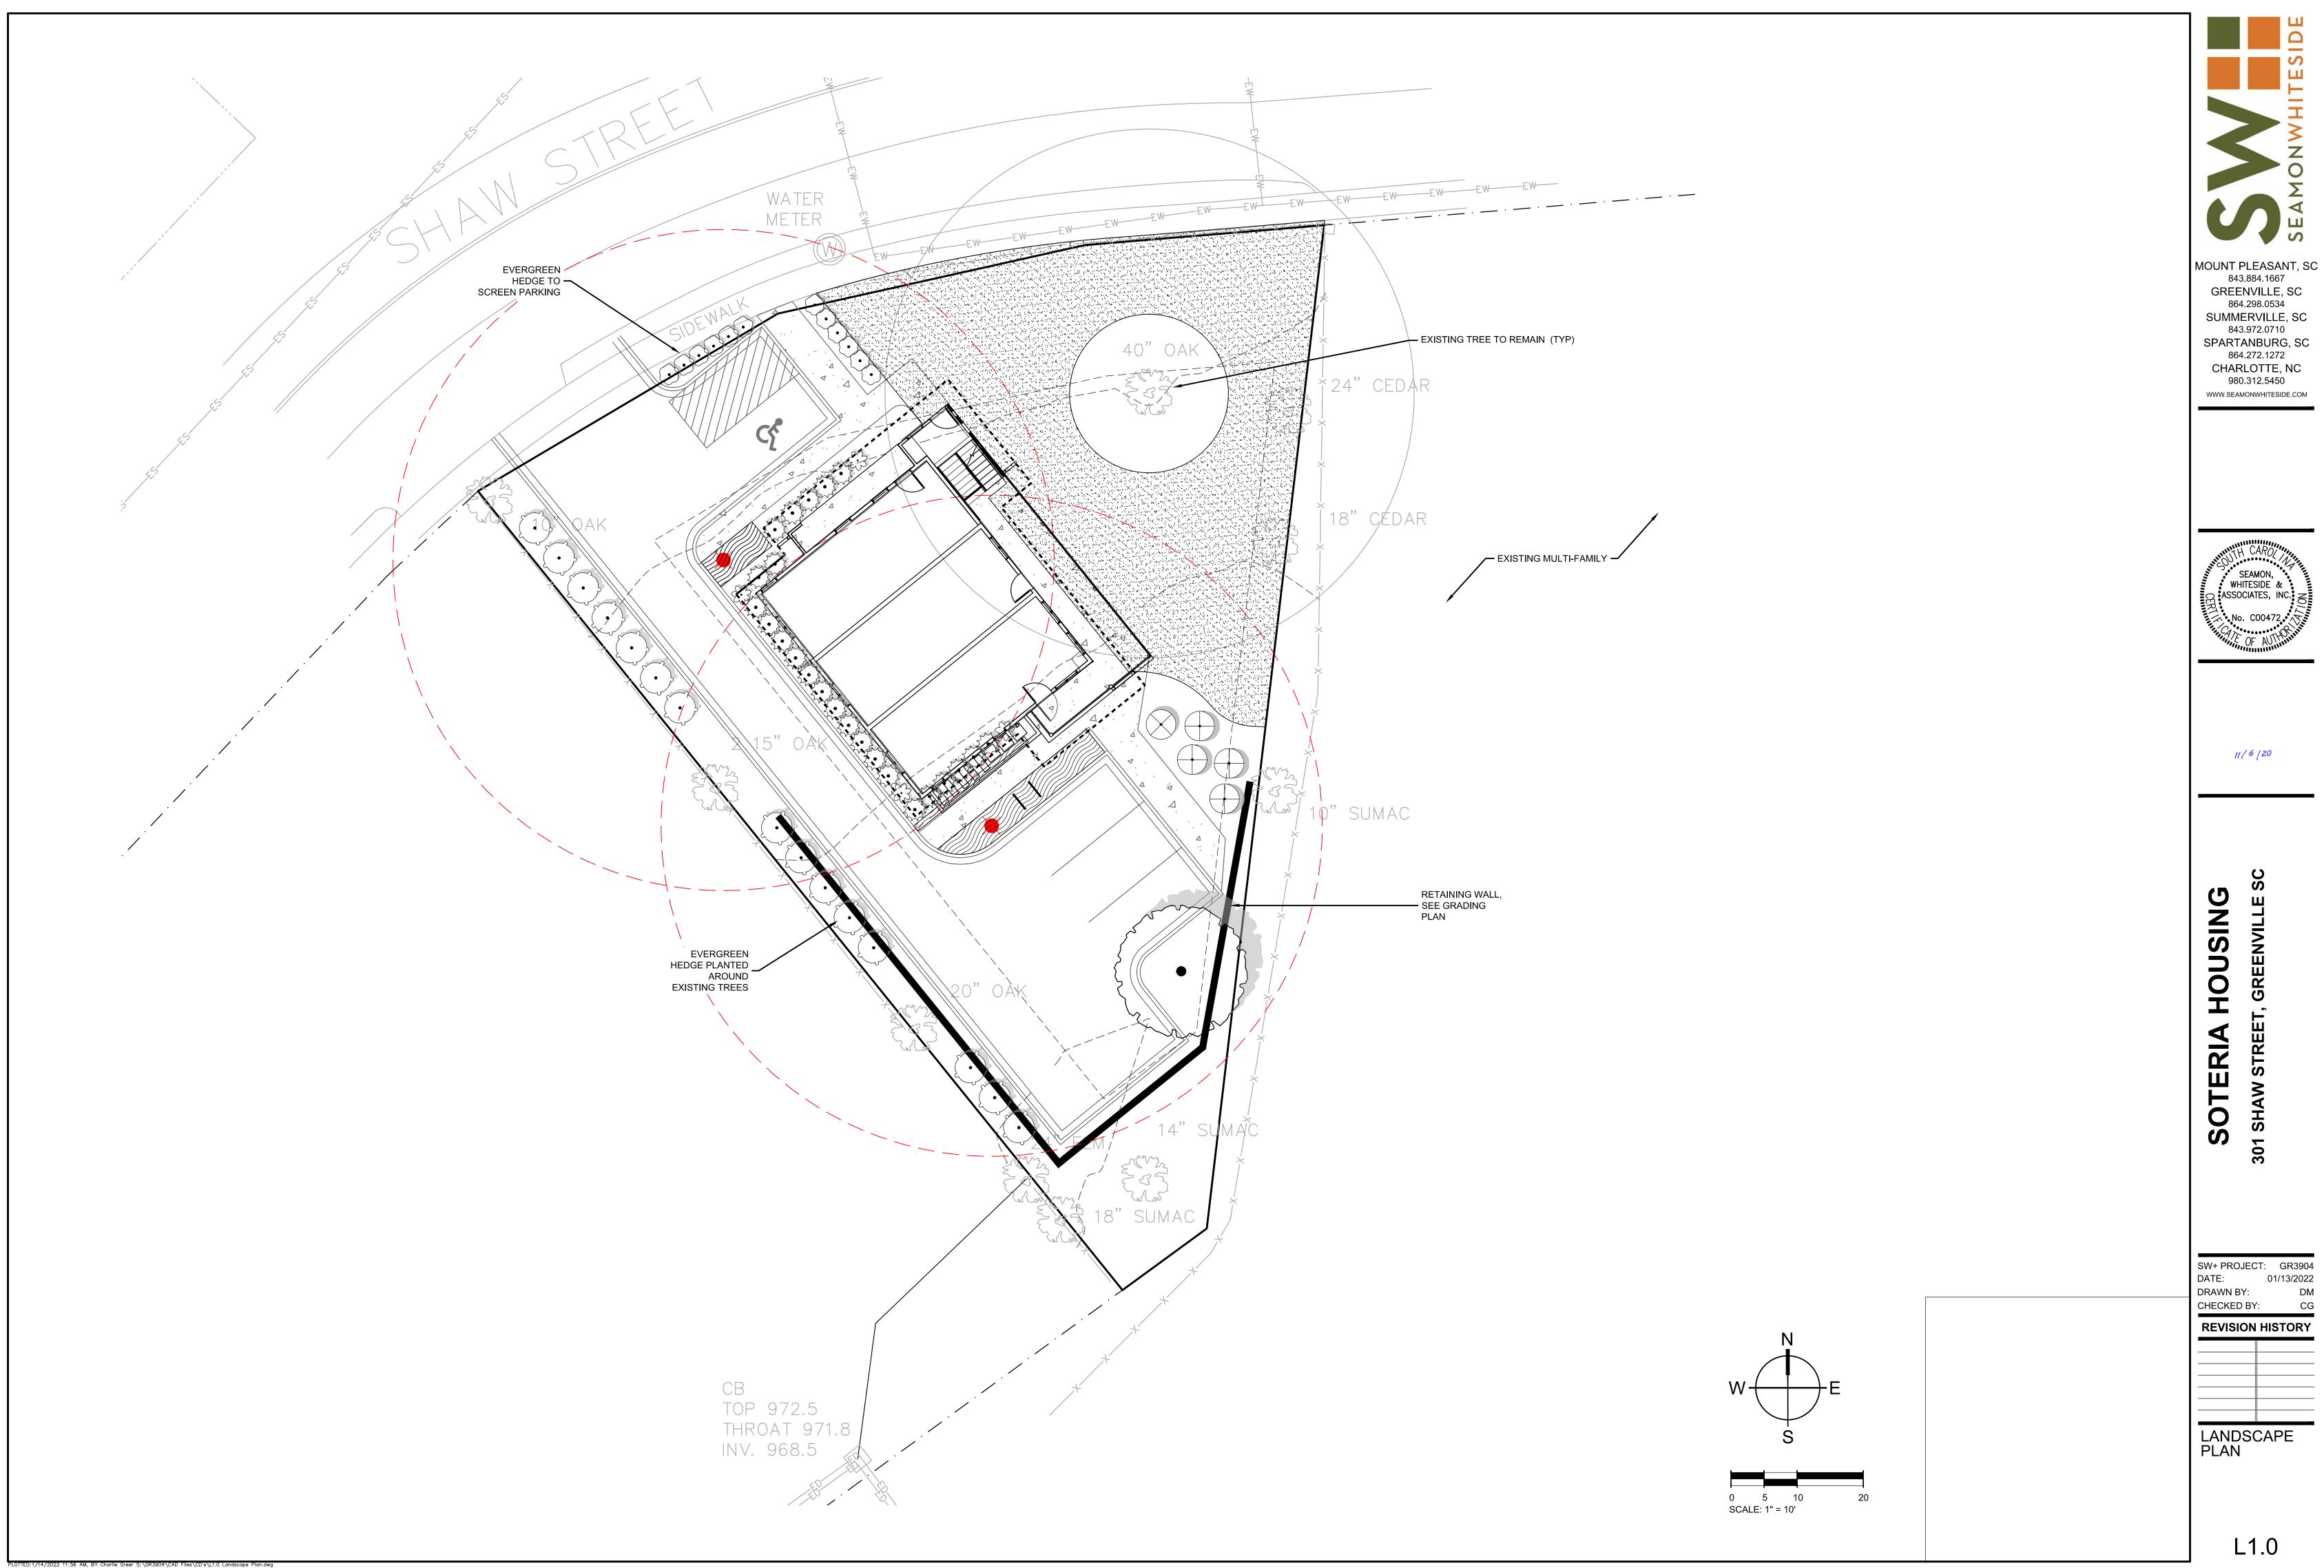


843.884.1667 GREENVILLE, SC 864.298.0534 SUMMERVILLE, SC 843.972.0710 SPARTANBURG, SC 864.272.1272 CHARLOTTE, NC 980.312.5450 WWW.SEAMONWHITESIDE.COM




SW+ PROJECT: GR3904 DATE: 01/13/2022 DRAWN BY: DM **REVISION HISTORY** 

LANDSCAPE PLAN

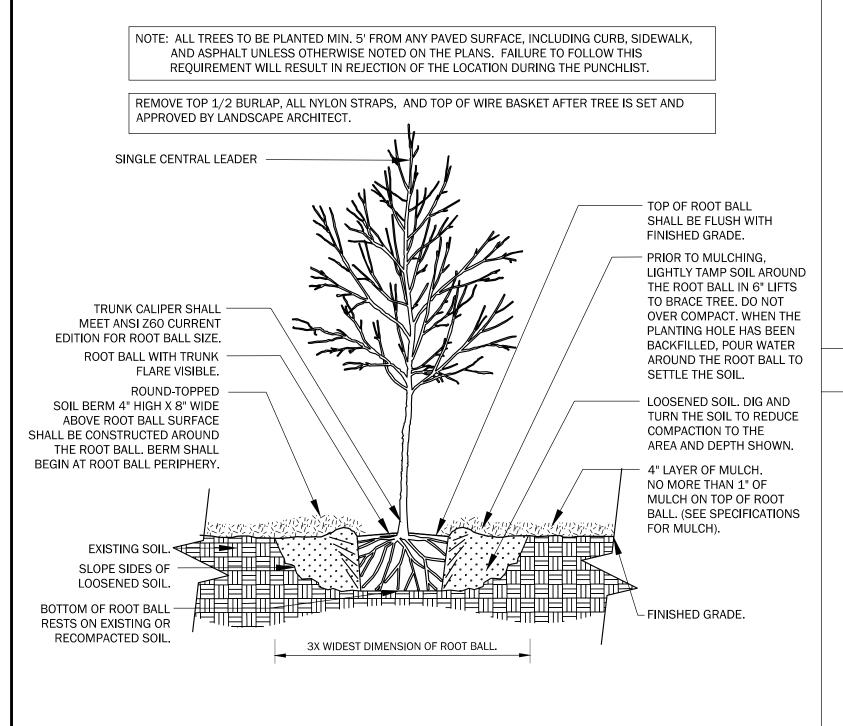

#### FINISH GRADE MULCH - 2" SETTLED DEPTH, KEEP AWAY FROM STEMS (ONLY AT DRIP IRRIGATION) PLANTING SOIL PREPARED SUBGRADE 1. SEPARATE AND SPREAD POT-BOUND ROOTS. DIP ROOT BALLS INTO SOLUTION OF ROOT DIP BEFORE PLANTING.

### HERBACEOUS PLUG PLANTING

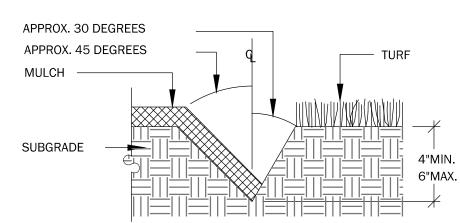


1. EXCAVATE TRENCH BY HAND W/ SPADE 2. ADD EXCESS SOIL TO ADJACENT PLANT BED AFTER PULLING BACK EXISTING MULCH. RAKE SOIL AND SMOOTH BEFORE MULCHING.

2. HYDRO-MULCH ALL PLUGGED AREAS NOT

RECEIVING DRIP IRRIGATION PRIOR TO


### TREE PLANTING

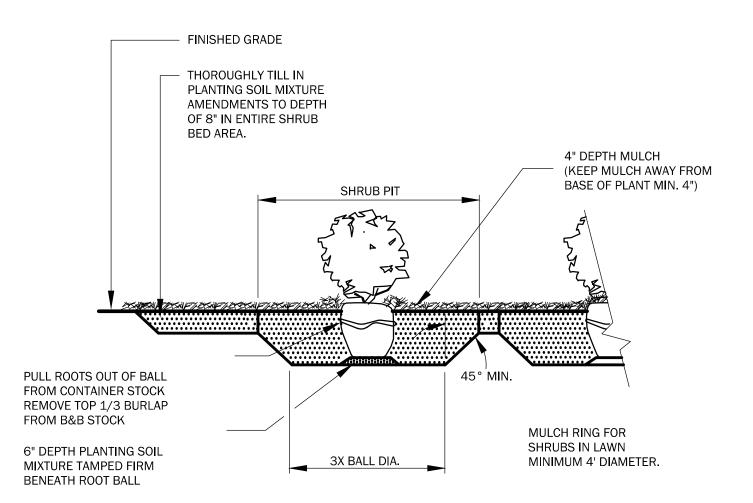

#### **GENERAL NOTES:**

- 1. PLANT SO THAT TOP OF ROOT BALL IS 1" ABOVE FINISH GRADE. 2. SCARIFY SIDES AND BOTTOM OF PIT.
- 3. BACKFILL SHRUB PIT WITH SPECIFIED PLANTING SOIL MIXTURE IN 6" LAYERS, HAND-TAMPED, TO REMOVE VOIDS. 4. WHEN 2/3 BACKFILLED, FILL WITH WATER.
- 5. AFTER PLACING AND HAND-TAMPING FINAL LAYERS, WATER AGAIN UNTIL NO MORE WATER IS ABSORBED.

### SHRUB PLANTING

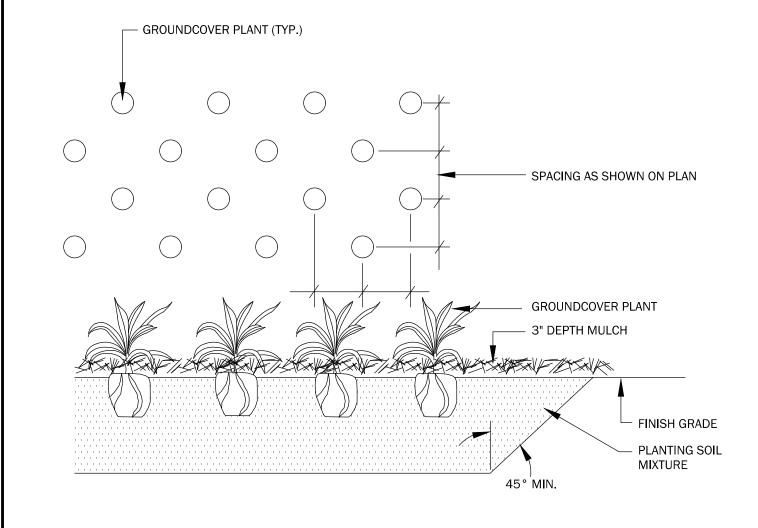

1. THOROUGHLY TILL IN PLANTING SOIL MIXTURE AMENDMENTS TO DEPTH OF 8" IN ENTIRE GROUNDCOVER BED AREA. 2. WORK SOIL TO LOOSE, UNIFORMLY FINE TEXTURE. 3. HAND-TAMP BACKFILL TO REMOVE VOIDS AND AIR POCKETS 4. WATER IMMEDIATELY AFTER PLANTING UNTIL NO MORE WATER IS ABSORBED.

### SOIL NOTES

1. FOR EACH UNAMENDED SOIL TYPE, FURNISH SOIL ANALYSIS AND A WRITTEN REPORT BY A QUALIFIED SOIL-TESTING LABORATORY STATING PERCENTAGES OF ORGANIC MATTER; GRADATION OF SAND, SILT, AND CLAY CONTENT; CATION EXCHANGE CAPACITY; SODIUM ABSORPTION RATIO; DELETERIOUS MATERIAL; BUFFER PH LEVELS; AND MINERAL AND PLANT-NUTRIENT CONTENT OF THE SOIL.

HORTICULTURAL TRENCH AT LAWN EDGE

- 2. A MINIMUM OF THREE REPRESENTATIVE SAMPLES SHALL BE TAKEN FROM VARIED LOCATIONS FOR EACH SOIL TO BE USED OR AMENDED FOR PLANTING PURPOSES.
- 3. SUBMIT TO LANDSCAPE ARCHITECT THE LAB RECOMMENDATIONS FOR SOIL TREATMENTS AND SOIL AMENDMENTS TO BE INCORPORATED. INDICATE LAB RECOMMENDATIONS IN WEIGHT PER 1000 SQ. FT. OR VOLUME PER CU. YD. FOR NITROGEN, PHOSPHORUS, AND POTASH NUTRIENTS AND ORGANIC AND INORGANIC SOIL AMENDMENTS TO BE ADDED TO PRODUCE PLANTING SOIL SUITABLE FOR HEALTHY, VIABLE PLANTS.
- 4.  $\,$  ALL SOILS USED FOR PLANTING SHALL BE PREPARED AS NECESSARY USING ORGANIC AND INORGANIC SOIL AMENDMENTS AND FERTILIZERS IN THE QUANTITIES RECOMMENDED IN THE SOIL ANALYSIS REPORT TO PRODUCE SATISFACTORY PLANTING SOIL FOR HEALTHY. VIABLE PLANTS. PLANTING SOILS SHALL HAVE A PH LEVEL BETWEEN 6.0 AND 7.0.
- 5. IN ALL PLANTING AREAS, SPREAD PLANTING SOIL TO A DEPTH OF 8 INCHES BUT NOT LESS THAN REQUIRED TO MEET FINISH GRADES AFTER NATURAL SETTLEMENT.

#### LANDSCAPE NOTES

- 1. CONTRACTOR TO PHOTO DOCUMENT PROGRESS OF WORK ON A WEEKLY BASIS AND SEND PHOTOS TO LANDSCAPE ARCHITECT AND OWNER ALONG WITH BRIEF SUMMARY OF WORK THAT HAS TAKEN PLACE.
- 2. CONTRACTOR SHALL VERIFY ALL DIMENSIONS, ELEVATIONS AND UTILITY LOCATIONS PRIOR TO BEGINNING WORK. 3. CONTRACTOR SHALL NOTIFY LANDSCAPE ARCHITECT OF ANY DISCREPANCIES PRIOR TO BEGINNING OR CONTINUING
- 4. THERE WILL BE NO SUBSTITUTIONS, DELETIONS OR ADDITIONS WITHOUT APPROVAL OF THE LANDSCAPE ARCHITECT. 5. SIZE OF PLANT MATERIALS SHALL CONFORM WITH THE CURRENT EDITION OF 'AMERICAN STANDARD FOR NURSERY STOCK' FOR NUMBER ONE GRADE NURSERY STOCK AS ADOPTED BY THE AMERICAN ASSOCIATION OF NURSERYMEN AND AMERICAN NATIONAL STANDARDS INSTITUTE.
- 6. CONTRACTOR SHALL MEET WITH LANDSCAPE ARCHITECT PRIOR TO BEGINNING WORK SO THAT THERE IS A CLEAR UNDERSTANDING OF PROJECT REQUIREMENTS. FAILURE TO DO SO JEOPARDIZES FINAL ACCEPTANCE OF WORK.
- 7. ALL CONSTRUCTION SHALL CONFORM TO CITY, COUNTY, STATE AND FEDERAL REQUIREMENTS. 8. LANDSCAPE ARCHITECT TO INSPECT QUALITY OF PLANT MATERIAL UPON ARRIVAL AT JOB SITE AND LAYOUT OF
- HARDSCAPE ELEMENTS AND PLANT MATERIAL PRIOR TO INSTALLATION. 9. DOUBLE SHREDDED HARDWOOD MULCH TO BE INSTALLED PER PLANTING DETAILS. MULCH ALL DISTURBED AREAS
- NOT COVERED BY PAVEMENT OR SEEDING. SEE PLAN FOR OTHER MULCH MATERIALS REQUIRED.
- 10. PROTECT EXISTING TREES TO REMAIN FROM DAMAGE. 11. THIS PLAN IS SCHEMATIC AND, DUE TO THE NATURE OF CONSTRUCTION, SLIGHT FIELD MODIFICATIONS MAY BE
- NECESSARY TO IMPLEMENT THIS PLAN.
- 12. SHAPE AND HEIGHT OF BERMS AS NOTED ON PLANS TO BE APPROVED BY LANDSCAPE ARCHITECT IN FIELD PRIOR TO PLANTING AND IRRIGATION CONSTRUCTION.

#### IRRIGATION PERFORMANCE SPECIFICATIONS

- CONTRACTOR TO INSTALL HIGH EFFICIENCY, FULLY CONTROLLED AUTOMATIC IRRIGATION SYSTEM WITH RAIN SENSOR PER IRRIGATION DRAWINGS AND SPECIFICATIONS AND PROVIDE SHOP DRAWINGS FOR LANDSCAPE
- 2. IT SHALL BE THE RESPONSIBILITY OF THE IRRIGATION CONTRACTOR TO MAKE SURE THAT ALL EQUIPMENT CONFORMS TO REQUIREMENTS OF ALL AUTHORITIES HAVING JURISDICTION AND MAKE ALL NECESSARY APPLICATIONS AND
- DESIGN STATISTICS: 60 P.S.I. MAXIMUM. IF NEEDED DUE TO EXISTING LINE PRESSURE, INSTALL A REDUCTION VALVE. IN ADDITION, ZONES THAT OPERATE SPRAY SPRINKLERS AND MP ROTATOR SPRINKLERS SHOULD HAVE A PRESSURE REGULATING DEVICE ADDED TO THE ZONE CONTROL VALVE TO FURTHER REDUCE THE PRESSURE ON THESE ZONES TO 35-40 P.S.I.
- 4. ALL IRRIGATION HEADS THAT ARE LOCATED NEXT TO DRIVES AND ROADWAYS SHALL BE MOUNTED ON SWING JOINTS OR ON 200 P.S.I. RATED FLEXIBLE PIPE. POSITION HEADS A MINIMUM 3" FROM CURB OR PAVEMENT.
- 5. ADJUST ALL HEADS FOR COMPLETE COVERAGE WITH MINIMUM OVERSPRAY BEYOND LANDSCAPE AREAS. 6. WHERE NOT OTHERWISE INDICATED, HEADS IN LAWN AREAS SHALL BE 4" POP-UP AND SHRUB AND GROUNDCOVER
- AREAS SHALL BE DRIP IRRIGATED. 7. SYSTEM PIPE SHALL BE CLASS 160 P.V.C. SIZE OF MAIN PIPE IS AS NOTED ON PLANS. SIZE ALL OTHER PIPE AS
- - 18-28 G.P.M.: 1-1/4" 29-35 G.P.M.: 1-1/2" 36-62 G.P.M.: 2" 63+ G.P.M.: 2-1/2"

**NOTES** 

- 8. WHERE POSSIBLE, COMBINE MAIN AND LATERAL PIPES IN SAME TRENCH.
- 9. ALL CONTROL WIRES SHALL BE 14 GAUGE. 10. CONTROLLER LOCATION AND MOUNTING TO BE APPROVED BY LANDSCAPE ARCHITECT. WHEN USED AS A MOUNT FOR THE CONTROL PANEL AND OTHER DEVICES, ALL LUMBER SHALL BE PRESSURE TREATED FOR GROUND CONTACT USE.
- ALL HARDWARE AND FASTENERS SHALL BE GALVANIZED 11. WHEN A MUNICIPAL WATER SUPPLY IS USED FOR IRRIGATION, WATER METER AND CONNECTION TO MAIN SHALL BE PROVIDED BY PERTINENT WATER AUTHORITY. CONTRACTOR SHALL BEGIN HIS WORK AT THE METER. OWNER WILL ASSUME THE COST OF THE TAP TO MUNICIPAL WATER SUPPLY AND IS RESPONSIBLE FOR COORDINATING THE
- INSTALLATION OF THE METER. 12. IF SYSTEM IS CONNECTED TO POTABLE WATER SUPPLY, PROVIDE BACKFLOW PREVENTION DEVICE IN ACCORDANCE WITH REQUIREMENTS OF ALL AUTHORITIES HAVING JURISDICTION. IF INSTALLED ABOVE GROUND, LOCATION OF
- DEVICE SHALL BE INCONSPICUOUS AND DEVICE SHALL BE PAINTED 'FLAT BLACK'. 13. PROTECT EXISTING TREES TO REMAIN FROM DAMAGE. NOT MACHINE TRENCHING IS ALLOWED WITHIN THE DRIP LINE OF ANY TREE. WHERE PIPING IS REQUIRED WITHIN THE DRIP LINE, POSITION PIPES TO MINIMIZE DISTURBANCE OF ROOTS AND PERFORM ALL EXCAVATION BY HAND. DO NOT CUT ANY ROOTS LARGER THAN  $\frac{3}{4}$ " DIAMETER.
- 14. IRRIGATION PIPING, SPRINKLERS, AND OTHER EQUIPMENT MAY BE SHOWN OUTSIDE OF LANDSCAPE AREAS ON DRAWING FOR GRAPHIC CLARITY. ALL VALVE BOXES AND EQUIPMENT VAULTS SHALL BE LOCATED IN MULCH BEDS.

SP SPECIMEN MATERIAL CAL TRUNK CALIPER TF TREE FORM HABIT GAL GALLON CONTAINER

MS MULTI-STEMMED TRUNK

FWF FULL WELL FORMED

EGG EGG CAN CONTAINER

B&B BALLED AND BURLAPPED MATERIAL

CON CONTAINERIZED MATERIAI

BR BARE ROOT MATERIAL

ESP ESPALIER

TREES	CODE	QTY	BOTANICAL / COMMON NAME	SIZE	HEIGHT		REMARKS
	QUEP	1	Quercus phellos / Willow Oak	2.5" CAL	12`-14`		FWF, SP, CLEAR TRUNK TO 6'
SHRUBS	CODE	QTY	BOTANICAL / COMMON NAME	SIZE	HEIGHT		REMARKS
	AZGT	1	Azalea indica / Indica Azalea	7 GAL			FWF, SP, CON
	DIST	24	Distylium x 'PIIDIST-IV' TM / Linebacker Distylium	3 GAL			FWF, SP, CON
•	ILEB	12	llex cornuta 'Burfordii Nana' / Dwarf Burford Holly	3 GAL	18"-24"		FWF, SP, CON
	OSMF	15	Osmanthus fragrans / Sweet Olive	7 GAL			FWF, SP, CON
	THUJ	4	Thuja occidentalis 'Smaragd' / Emerald Green Arborvitae		4`-5`		FWF, SP, FULL TO GROUND
GROUND COVERS	CODE	QTY	BOTANICAL / COMMON NAME	SIZE	HEIGHT	SPACING	REMARKS
	LIRS	88	Liriope muscari 'Super Blue' / Super Blue Lilyturf	4" POT		18" o.c.	FWF, SP, CON
	SOD	2,876 sf	Cynodon dactylon / Bermuda Grass	SOD			TIF 419 OR EQUAL

NO IRRIGATION COMPONENTS, INCLUDING BUT NOT LIMITED TO, VALVE BOXES, CONTROL BOXES, BACKFLOW PREVENTERS, AND/OR RAIN SENSORS ARE ALLOWED TO BE INSTALLED WITHIN DEPARTMENT OF TRANSPORTATION RIGHT-OF-WAY.

PLANT SCHEDULE

MOUNT PLEASANT, SC 843.884.1667 GREENVILLE, SC 864.298.0534 SUMMERVILLE, SC 843.972.0710 SPARTANBURG, SC 864.272.1272 CHARLOTTE, NC 980.312.5450 WWW.SEAMONWHITESIDE.COM

WHITESIDE & ASSOCIATES, IN

0

SW+ PROJECT: GR3904 01/13/2022 DRAWN BY: CHECKED BY: **REVISION HISTORY** 

PLANT SCHEDULE & **DETAILS** 

GROUNDCOVER PLANTING

**Neighborhood Meeting** 

Project Name: SOTERIA HOUSING

Location: VIRTUAL, Via Microsoft Teams

Time of the meeting: 6 pm

Date: Thursday, January 13, 2022

Representative holding meeting: Luke W. Perry, Johnston Design Group

Nan	ne	Street Address	Email
1	John (Anonymous)		
2	Linda and William Harkins	102 Conyers St. Greenville, SC	lucyandbill12@gmail.com
3	Kirsten Meier	325 Shaw St. Greenville, SC 29609	meieruk@gmail.com
4	Slowik Household	160 Stall Street	did not provide
5	Gary Davis	1116 S. Main Street, Greenville, SC 29601	gary.davis@captrust.com
6	Jerry Blassingame	201 Shaw St. Greenville, SC 29609	jblassingame@soteriacdc.org
7	Luke W. Perry	101 Alpine Way, Greenville, SC 29609	luke@johnstondesign.group
8	Paul Dow	COG Engineering	
9	Rebecca Edwards	COG Community Development	
10	Austin Rutherford	COG Planning	
11			
12	·	64-422-8045) called me to learn more about the project. S	he was mainly curious,
13	but said "sounds like a good project."		
14			
15			
16			
17			
18			
19			
20			
21			
22			
23			
24			
25			



Luke Perry

Project Manager

411 University Ridge, Suite D

#### APPLICATION FOR MULTIFAMILY DEVELOPMENT

**APPLICANT** 

Contact Planning & Development (864) 467-4476

Office Use Only: Application#	Fees Paid
Date Received	Accepted By
Date Complete	App Deny Conditions

PROPERTY OWNER

Soteria CDC

Owner

201 Shaw St.

#### **APPLICANT/OWNER INFORMATION**

#### \*Indicates Required Field

\*Name:

\*Title:

*Address:	411 University Ridge, Suite D	201 Shaw St.
*State:	SC	SC
*Zip:	29601	29609
*Phone:	864-250-0701	864-271-8227
*Email:	luke@johnstondesigngroup.us	jblassingame@soteriacdc.org
	PROPERTY INFORI	MATION_
*STREET AD	DDRESS 301 Shaw St.	
*TAX MAP #	0150001301200	
*CURRENT 2	ZONING DESIGNATION RM-2	
*TOTAL ACR	REAGE 0.26 Acres	
	PROPOSED DEVELOPMEN	T INFORMATION
*TYPE OF AI	PPLICATION: X NewModification – Ma	jorModification – Minor
*ORIGINAL A	APPLICATION # (put N/A if new application)N/A	
*NUMBER O	F UNITS 5	
*MULTIFAMI	LY DEVELOPMENT TYPE Rental Apartments	
*AGE RESTF	RICTED HOUSING (Y / N)N	
NUMBER OF	UNITS AND/OR PERCENTAGE OF AGE RESTRICT	ED UNITS (If applicable)
	INSTRUCTION	<u>NS</u>
	licant is <b>required</b> to schedule a pre-application me . Call (864) 467-4476 to schedule an appointment.	eeting according to the dates outlined on the Board
	*PREAPPLICATION MEETING DATE12	2/8/21
	olication includes more than one (1) parcel and/or mo	re than one (1) owner, the applicant must provide the address owner signatures as an attachment.

3. All applications and fees (made payable to the City of Greenville) for designation as a Multifamily Development must

be received by no later than 2:00 pm of the date reflected on the Board schedule.

	B. Multifamily development – Major	Modification	\$275.00 – public hearing required
	C. Multifamily development – Minor	Modification	\$150.00 – administrative review
4.	application is deemed insufficient, staf	f will notify the applicant and requents. In this event, the item will of	.2.6, Determination of Sufficiency. If the uest that the application be revised and go back into the queue for review. Please ditional information.
5.	<b>Public Notice Requirements.</b> Multifam There is also an informal review from the		re a Planning Commission public hearing. or to the planning commission hearing.
6.	The applicant is responsible for sign submission.	posting the subject property. Ins	tructions will be provided at the time of
7.	eight (8) days prior to the scheduled	Planning Commission hearing (	rhood meeting which is to be held <u>at least</u> Sec. 19-2.2.4, Neighborhood meetings). Dicant email provided on page one of this
8.	Upon planning commission recommend	ation, the application item will be so	heduled for city council hearing.
	To be filled out at time of application	<u>submittal</u>	
	X Public Hearing signs	are acknowledged as received by	the applicant
		ons and affidavit are acknowledged	
	*APPLICANT SIGNATURE Luks	Perry	
9.		on is reflected on the plan(s), and	submit one (1) paper copy and one (1)
10.			nformation submitted with this application; f their knowledge and they have provided
		a deed or other document places or	on the applicant's behalf has made a ne or more restrictions on the property that triction.
	applicant does not withdraw or modify the waived, then the planning office will in change would not likely result in the benefit of the planning of the planni	ne application in a timely manner, of dicate in its report to the planning efit the applicant seeks.	exists, it shall notify the applicant. If the or act to have the restriction terminated or commission that granting the requested
	Lu	ke Perry *APPLICA	NT ACKNOWLEDGEMENT SIGNATURE
	01/18/20	22	
11.		or <b>is not</b> _x restricted by ar	by affirms that the tract or parcel of land by recorded covenant that is contrary to,
	*Signatures		
	*Applicant	Luke Perry	
		1/18/2022	
	*Date	Jerry Blassingame	
	*Property Owner/Authorized Agent	Jerry Custinguite	
	*Date	1/18/2022	


\$550.00 – public hearing required


A. Multifamily development - New


#### **APPLICATION REQUIREMENTS**

- 1. Multifamily development format and content requirements are reflected in the City of Greenville Administrative Manual at Appendix 'H'.
- 2. The submitted information shall include at a minimum:
  - a. Completed application for Multifamily development;
  - b. Context map, showing relationship of proposed development to the surrounding neighborhood;
  - c. Photographs of surrounding area;
  - d. Site plan, showing building(s) footprint, parking lot layout, pedestrian and vehicular access, internal walkways, amenities (i.e. pool, playground, picnic area, etc.), and service areas (i.e. dumpster pad/trash collection area, HVAC units, car wash area, etc.);
  - e. Grading plan, showing existing and proposed topographic contours, storm drainage collection facilities, existing and proposed retaining walls (with top-of-wall and bottom-of-wall elevations for at least the ends of the walls and the high point of the walls);
  - f. Building elevations, of all sides of the building(s), with exterior materials and colors indicated;
  - g. Plan showing elevation of proposed buildings in relation to adjoining structures;
  - h. Building floor plans;
  - i. Landscape plan, showing existing vegetation that will remain and the new plants to be added;
  - *j.* Lighting plan, showing location of light fixtures (on the site and on the building), cut sheets of the proposed light fixtures, and wattage; and
  - k. Materials board.
- 3. Please refer to **Section 19-6.8, Design standards for multifamily residential development** for additional information.


#### **MD-22-57 • 301 SHAW STREET**

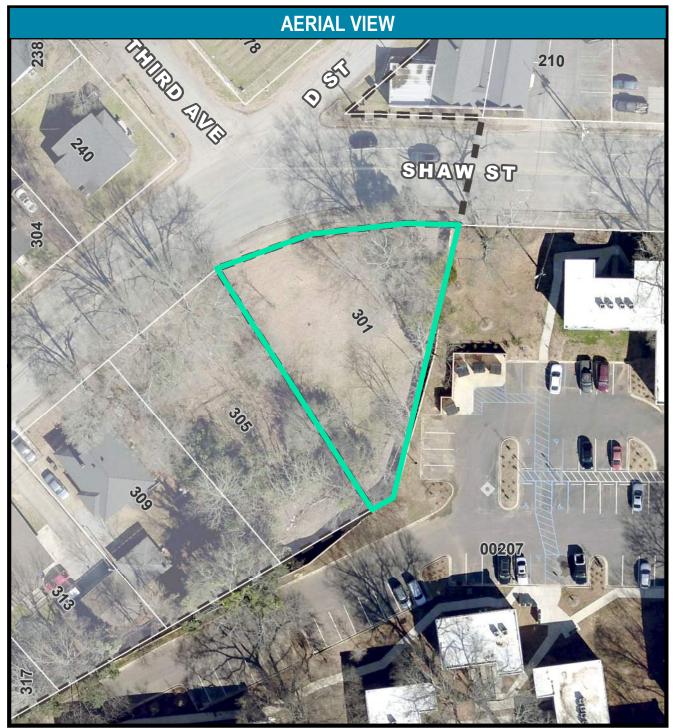


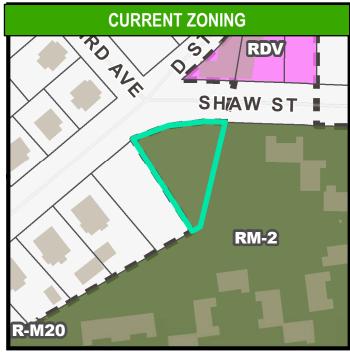


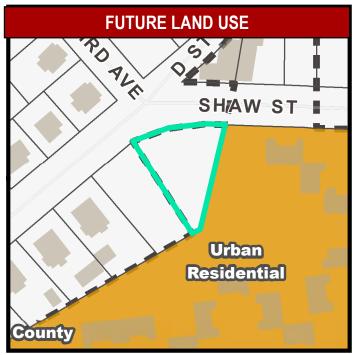

#### **MD-22-57 • 301 SHAW STREET**

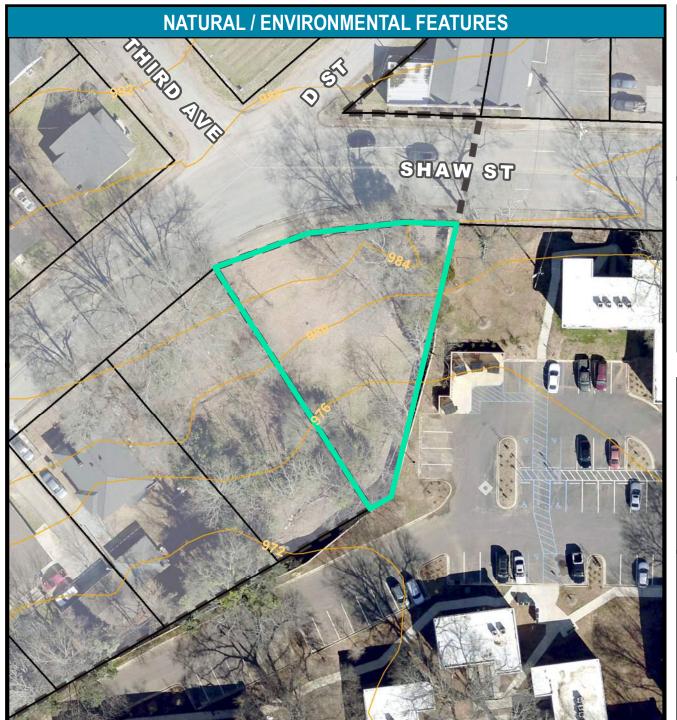

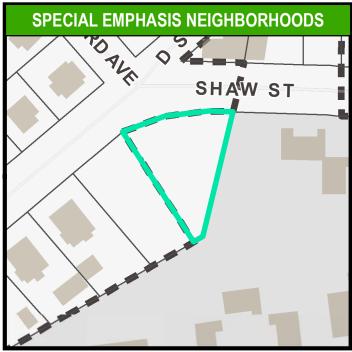

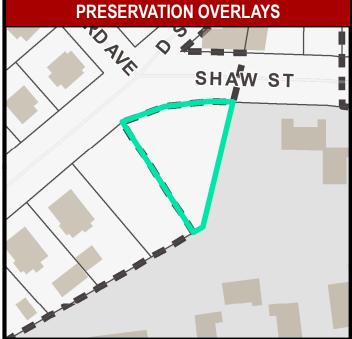





301 SHAW ST. GREENVILLE, SC

JOHNSTON DESIGN GROUP, LLC Suite D 411 UNIVERSITY RIDGE Greenville, SC 29601 ph: 864.250.0701

johnstondesigngroup.us

## FOR REVIEW ONLY

Re	visions	<b>5:</b>		
no.	date	by	checked	description

Commission: 219016 Date: 1/18/22 Drawn By: xxx Checked By:xxx

COVER SHEET &
PROJECT DATA

G1.01



301 SHAW ST. GREENVILLE, SC

JOHNSTON DESIGN GROUP, LLC Suite D 411 UNIVERSITY RIDGE Greenville, SC 29601 ph: 864.250.0701

johnstondesigngroup.us

## FOR REVIEW ONLY

Re	visions	5:		
no.	date	by	checked	description
A	1/18/22			PLANNING SUBMITTAL
į				
i —	L	1	1	

Commission: 219016
Date: 1/18/22
Drawn By: Author
Checked By: Checker

SITE PLAN

A1.00

### PROJECT INFO

ADDRESS:	301 SHAW ST.
PIN #:	0150001301200
PARCEL SIZE:	0.26 ACRES
PROPOSED ZONING:	RM-2 (CITY OF G
# OF UNITS BY RIGHT:	5
PROPOSED # OF UNITS:	5
PROPOSED BLDG SF:	2,200 +/- GSF
# PARK. SPACES REQ'D:	8 (1.5 × 5)
# PARK. SPACES PROVIDED:	5
CONSTRUCTION TYPE:	V-B
NFPA SPRINKLER SYSTEM:	NONE
UNITS TO BE CONDITIONED BY DI	JCTED MINI-SPLITS



301 SHAW ST. GREENVILLE, SC

JOHNSTON DESIGN GROUP, LLC Suite D 411 UNIVERSITY RIDGE Greenville, SC 29601 ph: 864.250.0701

johnstondesigngroup.us

FOR REVIEW ONLY

Re	visions	<b>:</b>		_
no.	date	by	checked	description
A	1/18/22			PLANNING SUBMITTAL
		<u> </u>		

Commission: 219016 Date: 1/18/22 Drawn By: xxx Checked By:xxx

FLOOR PLANS


FRONT FACADE NOTES: 1. TRANSPARENCY

OVERALL SF: 550 SF

OVERALL MIDTH: 40'-8" PORCH MIDTH: 18-10"

GLAZING SF: 110 SF % GLAZING: 20%

2. PORCH SIZE

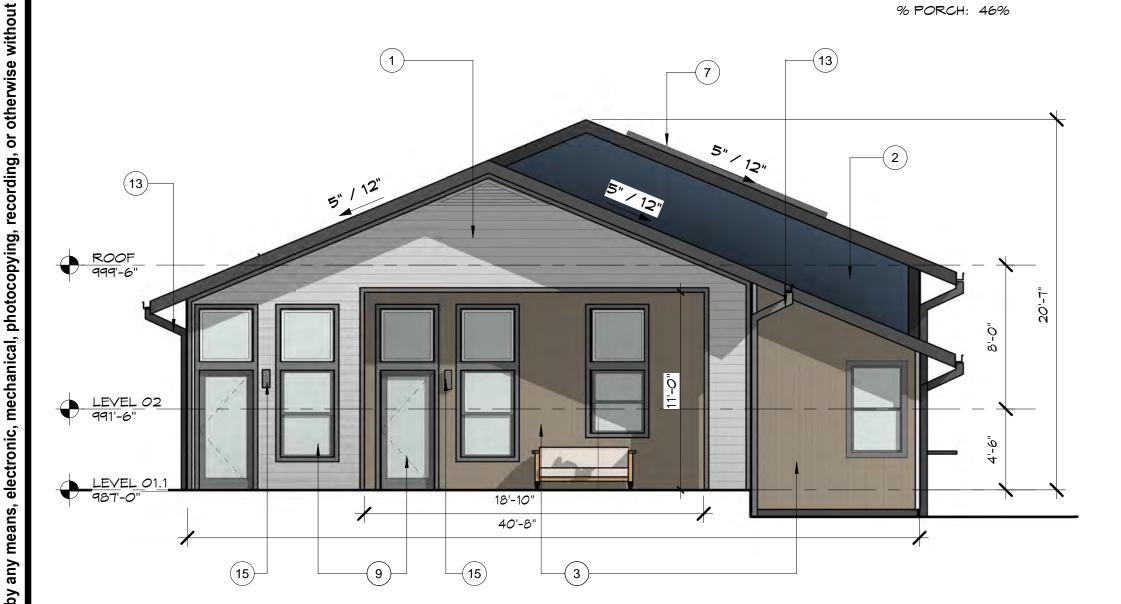

2 NORTH A1.02) 3/16" = 1'-0"







Johnston DESIGN GROUP

EXTERIOR NOTES

FIBER CEMENT LAP SIDING

RECLAIMED WOOD SIDING
ASPHALT SHINGLE ROOF
WOOD DECK/ PATIO
PAINTED METAL RAILING

PV SOLAR PANELS

EXHAUST VENTS

FIBER CEMENT BOARD AND BATTEN

HORIZONTAL SHADING ELEMENT

ALUM. CLAD WINDOWS & DOORS

OPENING IN EXTERIOR WALL

10 SCREEN WALL FOR MECH. EQUIP./ TRASH

SOTERIA

301 SHAW ST. GREENVILLE, SC

JOHNSTON DESIGN GROUP, LLC Suite D 411 UNIVERSITY RIDGE Greenville, SC 29601 ph: 864.250.0701

johnstondesigngroup.us

FOR REVIEW ONLY

Re	Revisions:						
no.	date	by	checked	description			
А	1/18/22			PLANNING SUBMITTAL			

Commission: 219016
Date: 1/18/22
Drawn By: xxx
Checked By:xxx

EXTERIOR ELEVATIONS

# 1STOPLIGHTING The 1 Stop Shop for All Your Lighting Needs



## P560051-30 - Z-1030 LED - Outdoor Light - 1 Light - in Modern style - 5.13 Inches wide by 12 Inches high by Progress Lighting

Family/Collection:	Z-1030
Length:	5.13"
Width/Diameter (in):	5.13"
Height:	12.00"
Depth/Extension:	5.75"
Shade Width at Top (inches):	3.13"
Shade Height (inches):	8.38"
Back Plate Length:	1.00°
Back Plate Width:	4.75"
Overall Length:	5.13W x 5.13L x 12H x 5.75D"
Shade Size:	3,13 x 8,38
Height from Center:	2.25"
Weight:	2.42 lbs
Wire Length:	6,00"
# of Bulbs:	1
Standard Wattage:	9 Watts
Bulb Type:	LED
CRI:	90
Lamp Base Type:	LED Module
Lumens:	333
Color Temperature;	3000 Kelvin
Design Style:	Modern
Shade Feature:	Seeded
Shade Shape:	Diffuser
Voltage Rating:	120 V
Material:	Aluminum
Warranty:	5 Years Limited
Prop 65 Rating:	Yes
Bulbs Included:	Yes
Shade Included:	Yes
Style and Option 1	
Style:	Antique Bronze Finish with Clear/Clear Seeded Glas
Item #:	P560051-020-30
Price:	<del>Reg. \$130.00</del> Save 15% \$110.50
Style and Option 2	
Style:	White Finish with Clear/Clear Seeded Glass
Item #;	P560051-030-30
Price:	Reg: \$130.00 Save 15%
2-12-12-1-1	
Style and Option 3	Black Finish with Clear/Clear Seeded Glass
Style and Option 3 Style:	Diack Fillish With Clear Geeded Glass
	P560051-031-30













*Reg. \$130.00*-Save 15% \$110.50

Metallic Gray Finish with Clear/Clear Seeded Glass





301 SHAW ST. GREENVILLE, SC

JOHNSTON DESIGN GROUP, LLC Suite D 411 UNIVERSITY RIDGE Greenville, SC ph: 864.250.0701

johnstondesigngroup.us

## FOR REVIEW ONLY

no.	date	by	checked	description
Α	1/18/22			PLANNING SUBMITTAL

Commission: 219016
Date: 1/18/22
Drawn By: Author
Checked By: Checker

EXTERIOR MATERIALS

A1.03

### **EXTERIOR MATERIALS & FINISHES** SOTERIA, GREENVILLE SC



PROGRESS EXTERIOR LED WALL SCONCE **BRONZE FINISH** 









GAS DIMENSIONAL ROOF SHINGLES BARKSTONE



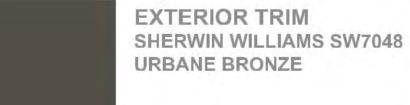



RECLAIMED VERTCAL WOOD SIDING

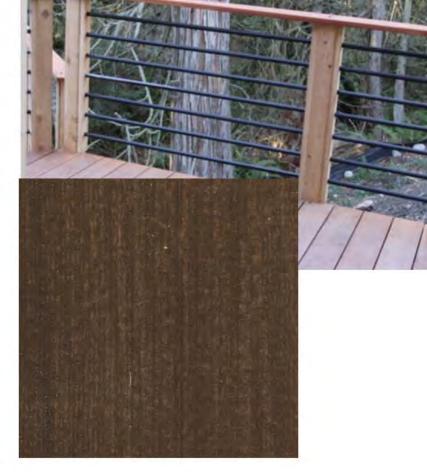

**WOOD & ROD RAIL SYSTEM** CABOT SEMI SOLID STAIN BURNT HICKORY

## Johnston DESIGN GROUP

LAP SIDING

**PASSIVE** 

SHERWIN WILLIAMS SW7064

**BOARD & BATTEN SIDING** SHERWIN WILLIAMS HGSW3341

SPECTRAL INDIGO



ADJACENT SINGLE FAMILY HOUSES TO THE WEST OF THE PROPOSED HOUSING



STRATHAM PLACE APARTMENTS, TO THE EAST OF PROPOSED HOUSING






EXISTING PARCEL AT 301 SHAW ST. LOOKING TOWARDS SOTERIA OFFICES AND STRATHAM PLACE



TYPICAL MILL HOUSING IN POE MILL NEIGHBORHOOD

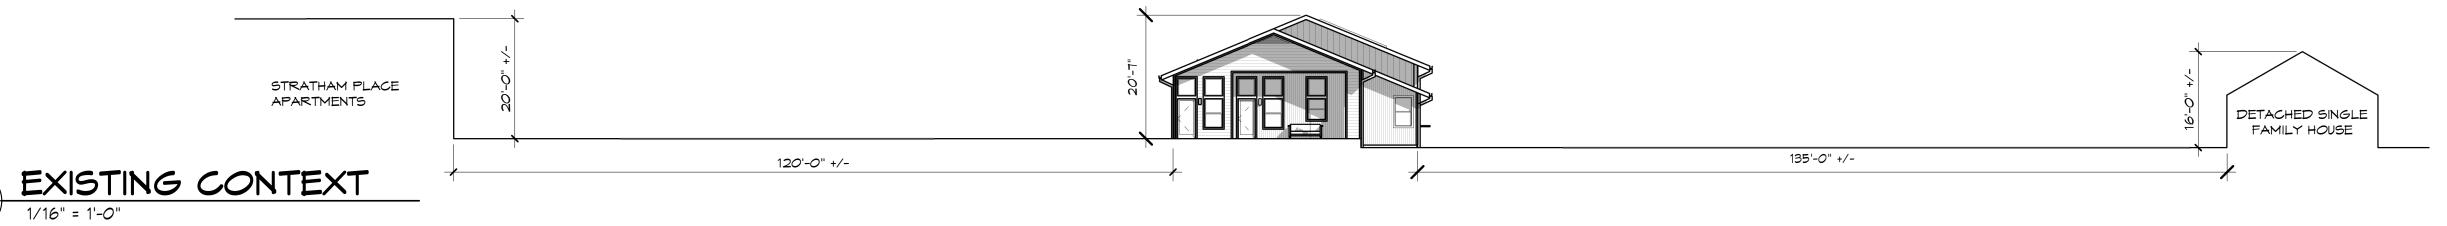



#### 301 SHAW ST. GREENVILLE, SC

#### JOHNSTON DESIGN GROUP, LLC Suite D 411 UNIVERSITY RIDGE Greenville, SC 29601 ph: 864.250.0701

johnstondesigngroup.us

## FOR REVIEW ONLY

10.	date	by	checked	description
Α	1/18/22			PLANNING SUBMITTAL

Commission: 219016
Date: 1/18/22
Drawn By: Author
Checked By: Checker

EXISTING CONDITIONS





301 SHAW ST. GREENVILLE, SC

JOHNSTON DESIGN GROUP, LLC Suite D 411 UNIVERSITY RIDGE Greenville, SC 29601 ph: 864.250.0701

johnstondesigngroup.us


FOR REVIEW ONLY


no.	date	by	checked	description
A	1/18/22			PLANNING SUBMITTAL

Commission: 219016
Date: 1/18/22
Drawn By: Author
Checked By: Checker

3D VIEWS

A1.05

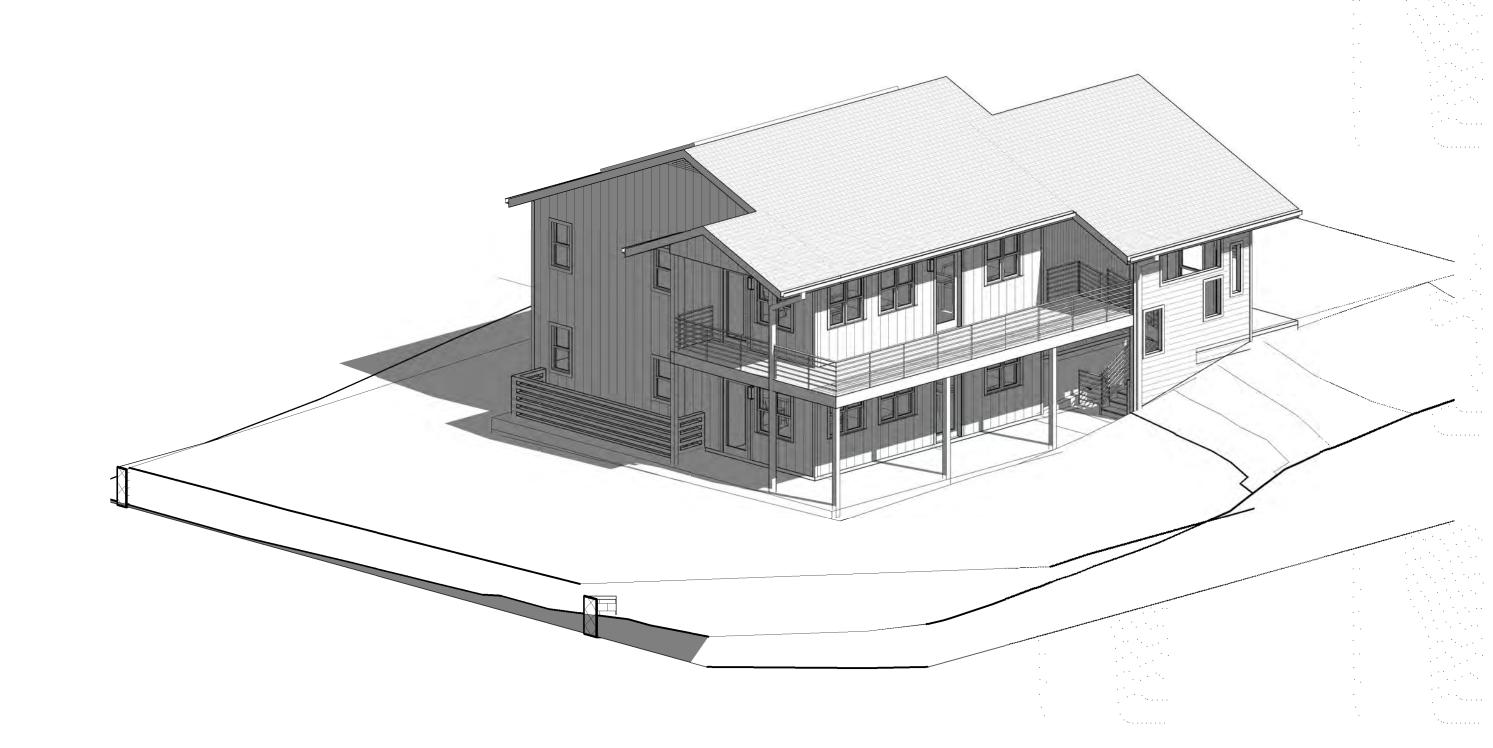

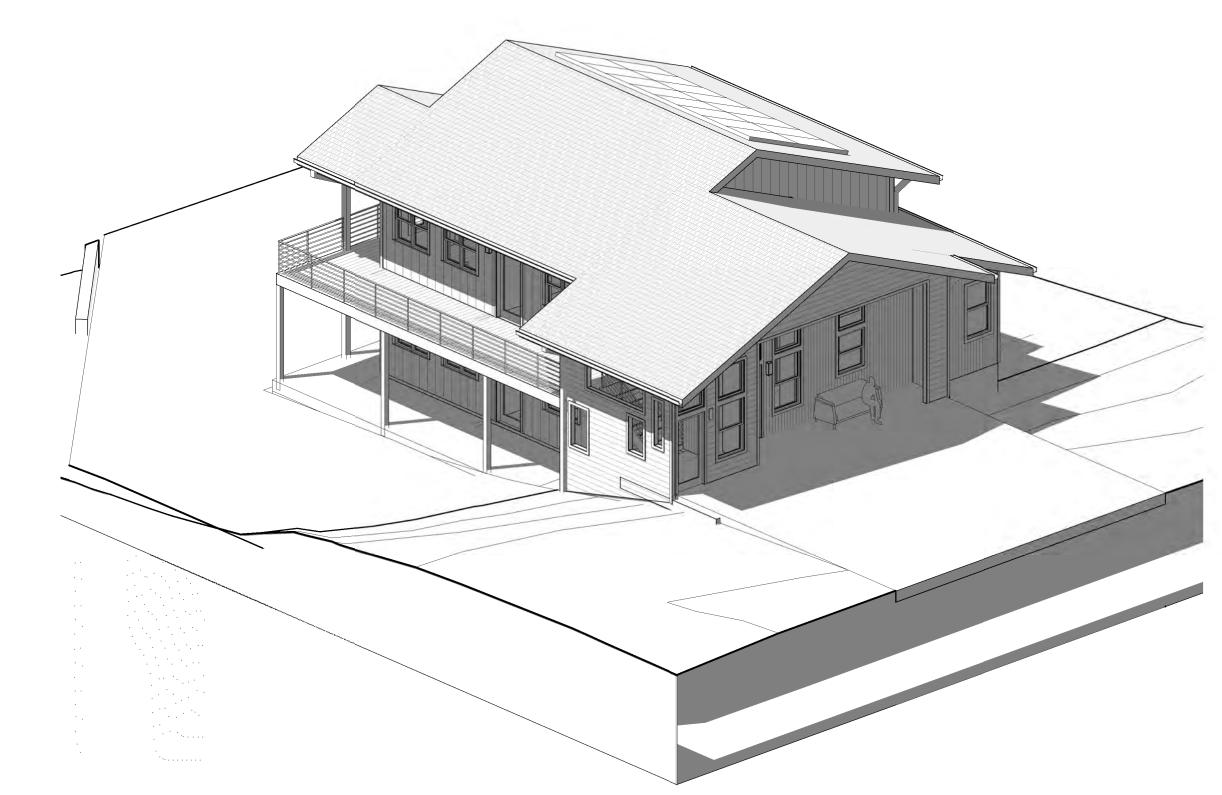








4 3D View 2 A1.05

1 AXON 2-

3 3D View 1 A1.05

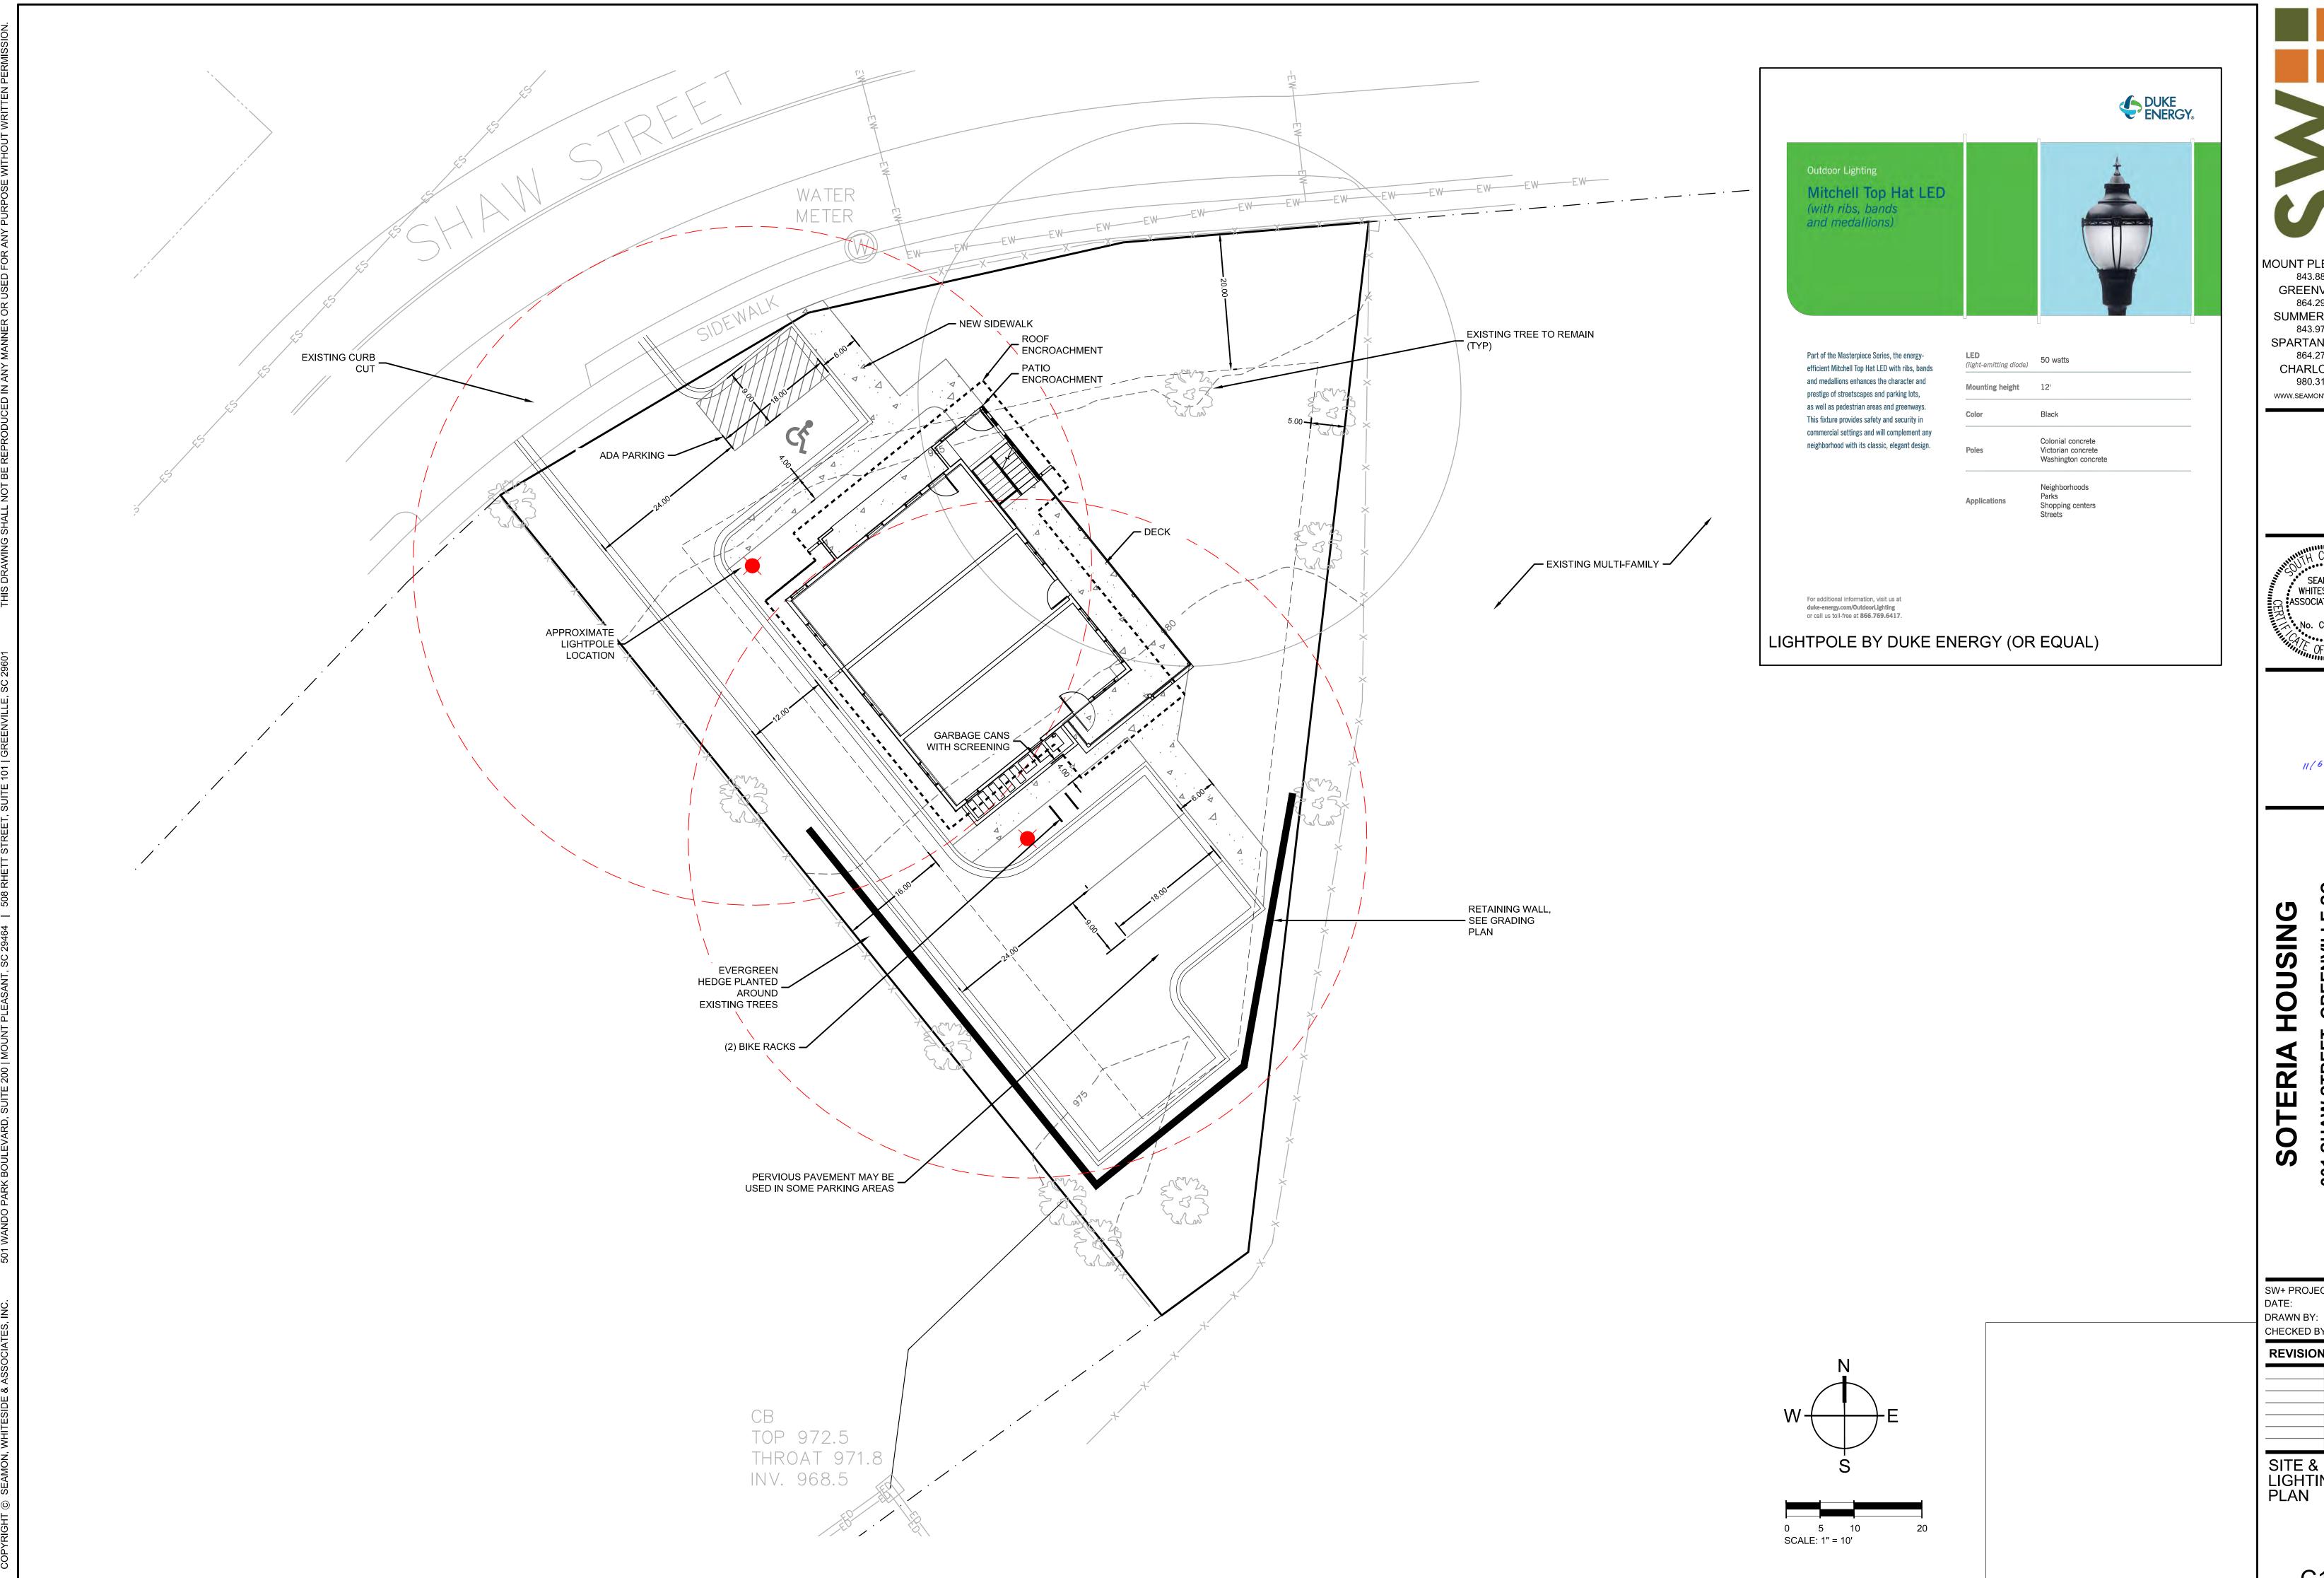

11/6/20

MOUNT PLEASANT, SC 843.884.1667 GREENVILLE, SC 864.298.0534 SUMMERVILLE, SC 843.972.0710 SPARTANBURG, SC 864.272.1272 CHARLOTTE, NC 980.312.5450 WWW.SEAMONWHITESIDE.COM




**REVISION HISTORY** 

SITE & LIGHTING PLAN

C1.0




MOUNT PLEASANT, SC 843.884.1667 GREENVILLE, SC 864.298.0534 SUMMERVILLE, SC 843.972.0710 SPARTANBURG, SC 864.272.1272 CHARLOTTE, NC 980.312.5450 WWW.SEAMONWHITESIDE.COM

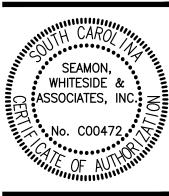

SW+ PROJECT: GR3904
DATE: 01/13/2022
DRAWN BY: DM
CHECKED BY: CG

REVISION HISTORY

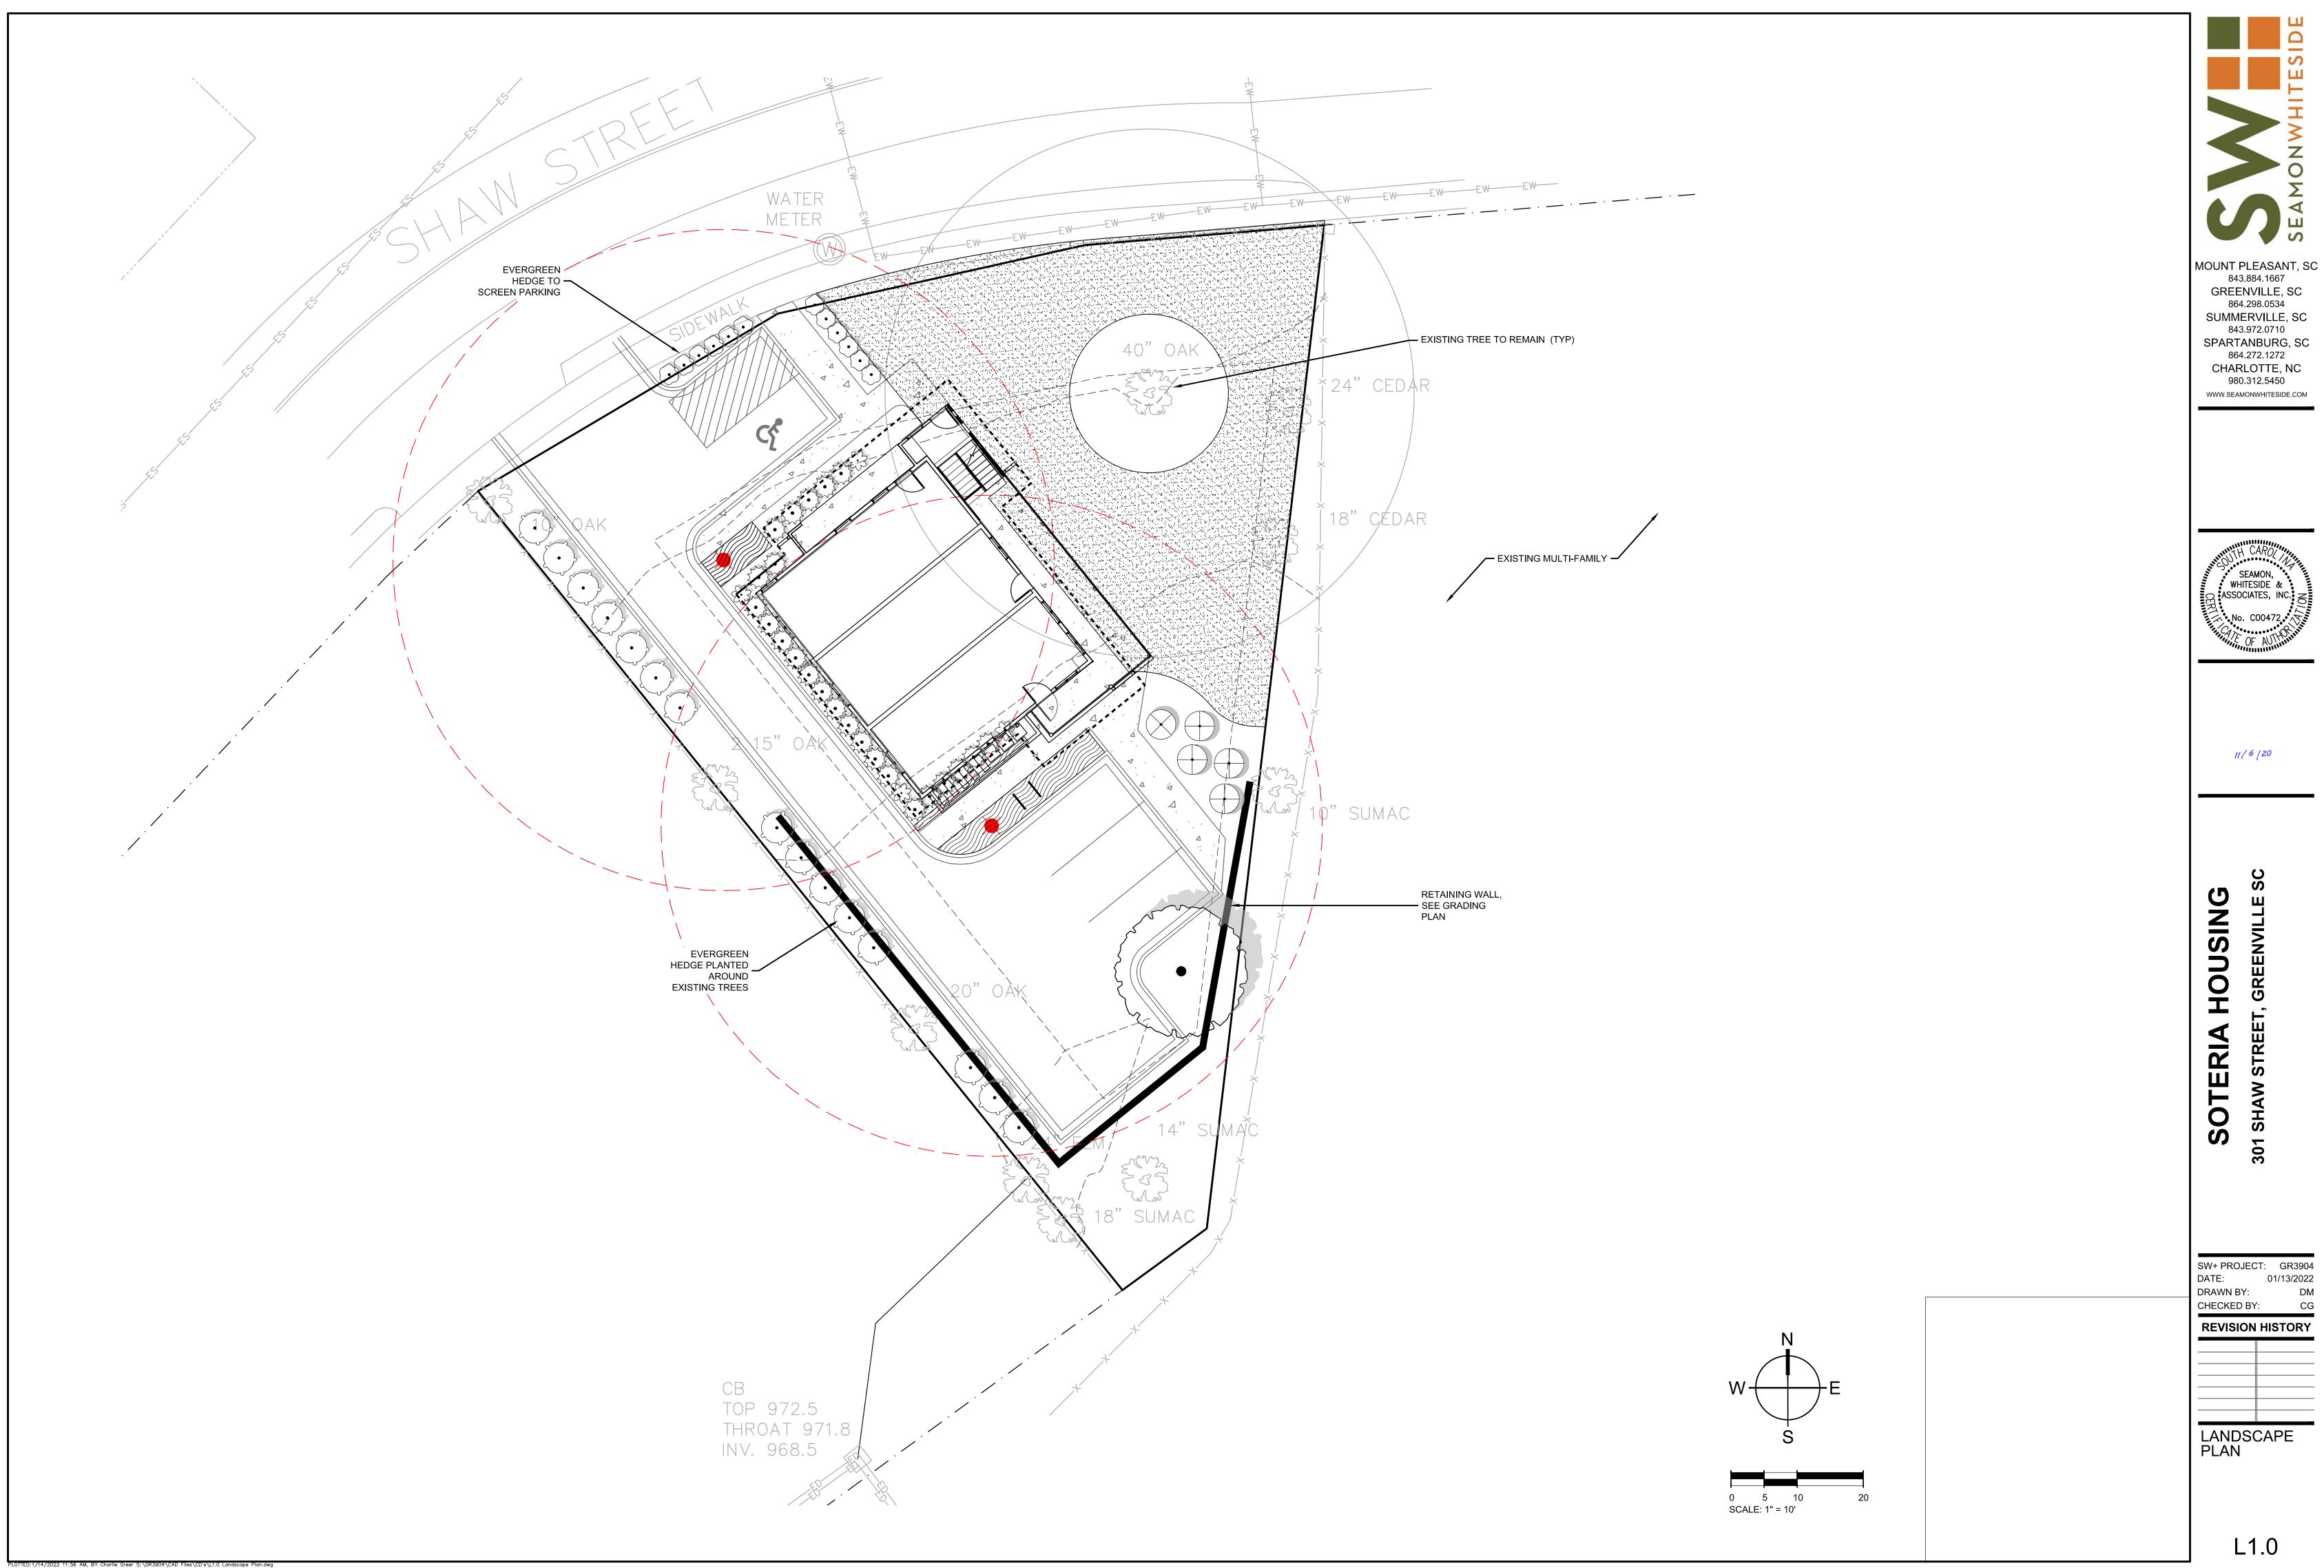


843.884.1667 GREENVILLE, SC 864.298.0534 SUMMERVILLE, SC 843.972.0710 SPARTANBURG, SC 864.272.1272 CHARLOTTE, NC 980.312.5450 WWW.SEAMONWHITESIDE.COM




SW+ PROJECT: GR3904 DATE: 01/13/2022 DRAWN BY: DM **REVISION HISTORY** 

LANDSCAPE PLAN

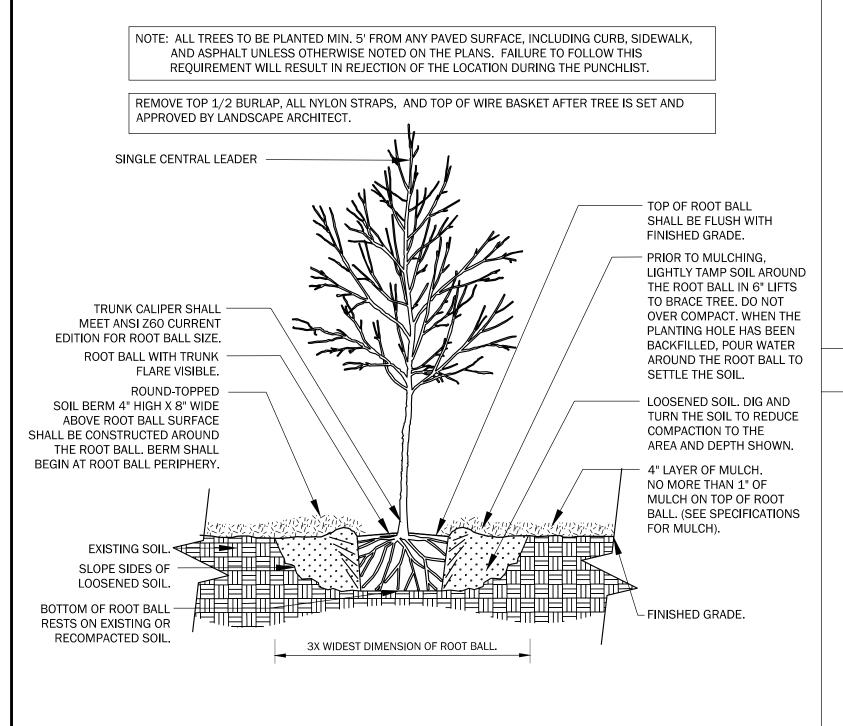

#### FINISH GRADE MULCH - 2" SETTLED DEPTH, **KEEP AWAY FROM STEMS** (ONLY AT DRIP IRRIGATION) PLANTING SOIL PREPARED SUBGRADE 1. SEPARATE AND SPREAD POT-BOUND ROOTS. DIP ROOT BALLS INTO SOLUTION OF ROOT DIP BEFORE PLANTING.

### HERBACEOUS PLUG PLANTING

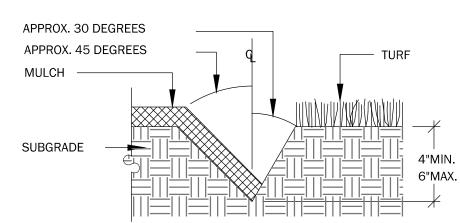


1. EXCAVATE TRENCH BY HAND W/ SPADE 2. ADD EXCESS SOIL TO ADJACENT PLANT BED AFTER PULLING BACK EXISTING MULCH. RAKE SOIL AND SMOOTH BEFORE MULCHING.

2. HYDRO-MULCH ALL PLUGGED AREAS NOT

RECEIVING DRIP IRRIGATION PRIOR TO


### TREE PLANTING

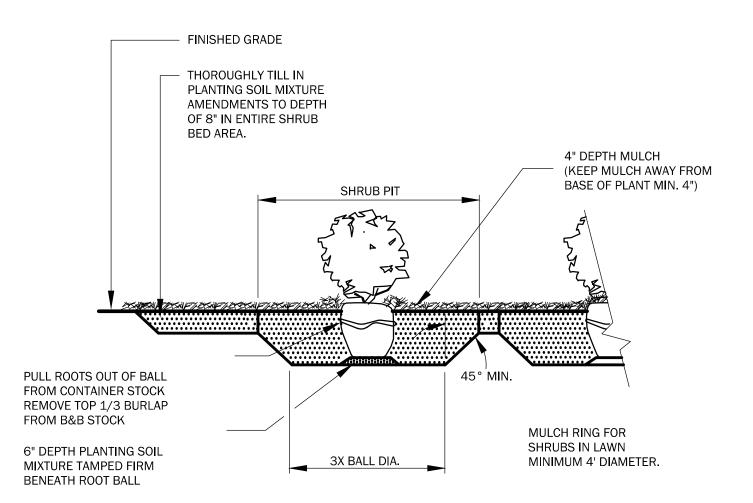

#### **GENERAL NOTES:**

- 1. PLANT SO THAT TOP OF ROOT BALL IS 1" ABOVE FINISH GRADE. 2. SCARIFY SIDES AND BOTTOM OF PIT.
- 3. BACKFILL SHRUB PIT WITH SPECIFIED PLANTING SOIL MIXTURE IN 6" LAYERS, HAND-TAMPED, TO REMOVE VOIDS. 4. WHEN 2/3 BACKFILLED, FILL WITH WATER.
- 5. AFTER PLACING AND HAND-TAMPING FINAL LAYERS, WATER AGAIN UNTIL NO MORE WATER IS ABSORBED.

### SHRUB PLANTING

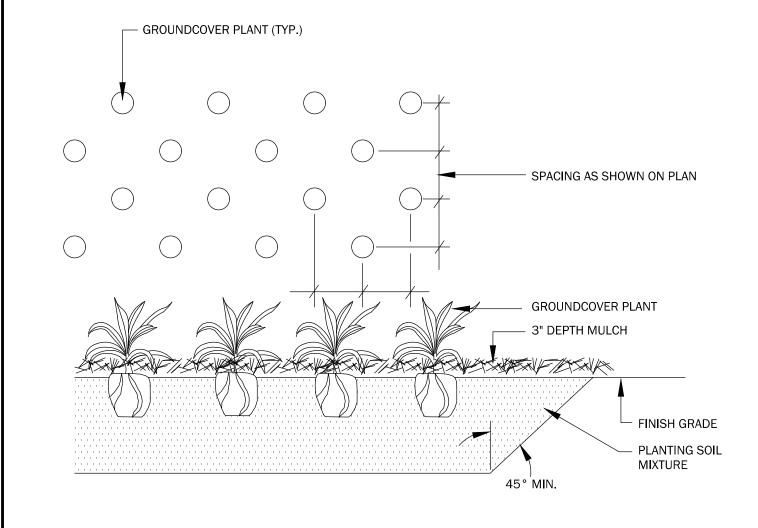

1. THOROUGHLY TILL IN PLANTING SOIL MIXTURE AMENDMENTS TO DEPTH OF 8" IN ENTIRE GROUNDCOVER BED AREA. 2. WORK SOIL TO LOOSE, UNIFORMLY FINE TEXTURE. 3. HAND-TAMP BACKFILL TO REMOVE VOIDS AND AIR POCKETS 4. WATER IMMEDIATELY AFTER PLANTING UNTIL NO MORE WATER IS ABSORBED.

GROUNDCOVER PLANTING

### SOIL NOTES

1. FOR EACH UNAMENDED SOIL TYPE, FURNISH SOIL ANALYSIS AND A WRITTEN REPORT BY A QUALIFIED SOIL-TESTING LABORATORY STATING PERCENTAGES OF ORGANIC MATTER; GRADATION OF SAND, SILT, AND CLAY CONTENT; CATION EXCHANGE CAPACITY; SODIUM ABSORPTION RATIO; DELETERIOUS MATERIAL; BUFFER PH LEVELS; AND MINERAL AND PLANT-NUTRIENT CONTENT OF THE SOIL.

HORTICULTURAL TRENCH AT LAWN EDGE

- 2. A MINIMUM OF THREE REPRESENTATIVE SAMPLES SHALL BE TAKEN FROM VARIED LOCATIONS FOR EACH SOIL TO BE USED OR AMENDED FOR PLANTING PURPOSES.
- SUBMIT TO LANDSCAPE ARCHITECT THE LAB RECOMMENDATIONS FOR SOIL TREATMENTS AND SOIL AMENDMENTS TO BE INCORPORATED. INDICATE LAB RECOMMENDATIONS IN WEIGHT PER 1000 SQ. FT. OR VOLUME PER CU. YD. FOR NITROGEN, PHOSPHORUS, AND POTASH NUTRIENTS AND ORGANIC AND INORGANIC SOIL AMENDMENTS TO BE ADDED TO PRODUCE PLANTING SOIL SUITABLE FOR HEALTHY, VIABLE PLANTS.
- 4.  $\,$  ALL SOILS USED FOR PLANTING SHALL BE PREPARED AS NECESSARY USING ORGANIC AND INORGANIC SOIL AMENDMENTS AND FERTILIZERS IN THE QUANTITIES RECOMMENDED IN THE SOIL ANALYSIS REPORT TO PRODUCE SATISFACTORY PLANTING SOIL FOR HEALTHY, VIABLE PLANTS. PLANTING SOILS SHALL HAVE A PH LEVEL BETWEEN 6.0 AND 7.0.
- 5.  $\,$  IN ALL PLANTING AREAS, SPREAD PLANTING SOIL TO A DEPTH OF 8 INCHES BUT NOT LESS THAN REQUIRED TO MEET FINISH GRADES AFTER NATURAL SETTLEMENT.

#### LANDSCAPE NOTES

- 1. CONTRACTOR TO PHOTO DOCUMENT PROGRESS OF WORK ON A WEEKLY BASIS AND SEND PHOTOS TO LANDSCAPE ARCHITECT AND OWNER ALONG WITH BRIFF SUMMARY OF WORK THAT HAS TAKEN PLACE.
- 2. CONTRACTOR SHALL VERIFY ALL DIMENSIONS, ELEVATIONS AND UTILITY LOCATIONS PRIOR TO BEGINNING WORK. 3. CONTRACTOR SHALL NOTIFY LANDSCAPE ARCHITECT OF ANY DISCREPANCIES PRIOR TO BEGINNING OR CONTINUING
- 4. THERE WILL BE NO SUBSTITUTIONS, DELETIONS OR ADDITIONS WITHOUT APPROVAL OF THE LANDSCAPE ARCHITECT. 5. SIZE OF PLANT MATERIALS SHALL CONFORM WITH THE CURRENT EDITION OF 'AMERICAN STANDARD FOR NURSERY STOCK' FOR NUMBER ONE GRADE NURSERY STOCK AS ADOPTED BY THE AMERICAN ASSOCIATION OF NURSERYMEN AND AMERICAN NATIONAL STANDARDS INSTITUTE.
- 6. CONTRACTOR SHALL MEET WITH LANDSCAPE ARCHITECT PRIOR TO BEGINNING WORK SO THAT THERE IS A CLEAR UNDERSTANDING OF PROJECT REQUIREMENTS. FAILURE TO DO SO JEOPARDIZES FINAL ACCEPTANCE OF WORK.
- ALL CONSTRUCTION SHALL CONFORM TO CITY, COUNTY, STATE AND FEDERAL REQUIREMENTS. 8. LANDSCAPE ARCHITECT TO INSPECT QUALITY OF PLANT MATERIAL UPON ARRIVAL AT JOB SITE AND LAYOUT OF
- HARDSCAPE ELEMENTS AND PLANT MATERIAL PRIOR TO INSTALLATION. 9. DOUBLE SHREDDED HARDWOOD MULCH TO BE INSTALLED PER PLANTING DETAILS. MULCH ALL DISTURBED AREAS
- NOT COVERED BY PAVEMENT OR SEEDING. SEE PLAN FOR OTHER MULCH MATERIALS REQUIRED. 10. PROTECT EXISTING TREES TO REMAIN FROM DAMAGE.
- 11. THIS PLAN IS SCHEMATIC AND, DUE TO THE NATURE OF CONSTRUCTION, SLIGHT FIELD MODIFICATIONS MAY BE
- NECESSARY TO IMPLEMENT THIS PLAN.
- 12. SHAPE AND HEIGHT OF BERMS AS NOTED ON PLANS TO BE APPROVED BY LANDSCAPE ARCHITECT IN FIELD PRIOR TO PLANTING AND IRRIGATION CONSTRUCTION.

#### IRRIGATION PERFORMANCE SPECIFICATIONS

- CONTRACTOR TO INSTALL HIGH EFFICIENCY, FULLY CONTROLLED AUTOMATIC IRRIGATION SYSTEM WITH RAIN SENSOR PER IRRIGATION DRAWINGS AND SPECIFICATIONS AND PROVIDE SHOP DRAWINGS FOR LANDSCAPE
- 2. IT SHALL BE THE RESPONSIBILITY OF THE IRRIGATION CONTRACTOR TO MAKE SURE THAT ALL EQUIPMENT CONFORMS TO REQUIREMENTS OF ALL AUTHORITIES HAVING JURISDICTION AND MAKE ALL NECESSARY APPLICATIONS AND
- DESIGN STATISTICS: 60 P.S.I. MAXIMUM. IF NEEDED DUE TO EXISTING LINE PRESSURE, INSTALL A REDUCTION VALVE. IN ADDITION, ZONES THAT OPERATE SPRAY SPRINKLERS AND MP ROTATOR SPRINKLERS SHOULD HAVE A PRESSURE REGULATING DEVICE ADDED TO THE ZONE CONTROL VALVE TO FURTHER REDUCE THE PRESSURE ON THESE ZONES TO 35-40 P.S.I.
- 4. ALL IRRIGATION HEADS THAT ARE LOCATED NEXT TO DRIVES AND ROADWAYS SHALL BE MOUNTED ON SWING JOINTS OR ON 200 P.S.I. RATED FLEXIBLE PIPE. POSITION HEADS A MINIMUM 3" FROM CURB OR PAVEMENT.
- 5. ADJUST ALL HEADS FOR COMPLETE COVERAGE WITH MINIMUM OVERSPRAY BEYOND LANDSCAPE AREAS. 6. WHERE NOT OTHERWISE INDICATED, HEADS IN LAWN AREAS SHALL BE 4" POP-UP AND SHRUB AND GROUNDCOVER
- AREAS SHALL BE DRIP IRRIGATED.
- SYSTEM PIPE SHALL BE CLASS 160 P.V.C. SIZE OF MAIN PIPE IS AS NOTED ON PLANS. SIZE ALL OTHER PIPE AS
  - 18-28 G.P.M.: 1-1/4" 29-35 G.P.M.: 1-1/2" 36-62 G.P.M.: 2" 63+ G.P.M.: 2-1/2"
- 8. WHERE POSSIBLE, COMBINE MAIN AND LATERAL PIPES IN SAME TRENCH.
- 9. ALL CONTROL WIRES SHALL BE 14 GAUGE. 10. CONTROLLER LOCATION AND MOUNTING TO BE APPROVED BY LANDSCAPE ARCHITECT. WHEN USED AS A MOUNT FOR THE CONTROL PANEL AND OTHER DEVICES, ALL LUMBER SHALL BE PRESSURE TREATED FOR GROUND CONTACT USE.
- ALL HARDWARE AND FASTENERS SHALL BE GALVANIZED 11. WHEN A MUNICIPAL WATER SUPPLY IS USED FOR IRRIGATION, WATER METER AND CONNECTION TO MAIN SHALL BE PROVIDED BY PERTINENT WATER AUTHORITY. CONTRACTOR SHALL BEGIN HIS WORK AT THE METER. OWNER WILL ASSUME THE COST OF THE TAP TO MUNICIPAL WATER SUPPLY AND IS RESPONSIBLE FOR COORDINATING THE
- INSTALLATION OF THE METER. 12. IF SYSTEM IS CONNECTED TO POTABLE WATER SUPPLY, PROVIDE BACKFLOW PREVENTION DEVICE IN ACCORDANCE WITH REQUIREMENTS OF ALL AUTHORITIES HAVING JURISDICTION. IF INSTALLED ABOVE GROUND, LOCATION OF
- DEVICE SHALL BE INCONSPICUOUS AND DEVICE SHALL BE PAINTED 'FLAT BLACK'. 13. PROTECT EXISTING TREES TO REMAIN FROM DAMAGE. NOT MACHINE TRENCHING IS ALLOWED WITHIN THE DRIP LINE OF ANY TREE. WHERE PIPING IS REQUIRED WITHIN THE DRIP LINE, POSITION PIPES TO MINIMIZE DISTURBANCE OF
- ROOTS AND PERFORM ALL EXCAVATION BY HAND. DO NOT CUT ANY ROOTS LARGER THAN  $\frac{3}{4}$ " DIAMETER. 14. IRRIGATION PIPING, SPRINKLERS, AND OTHER EQUIPMENT MAY BE SHOWN OUTSIDE OF LANDSCAPE AREAS ON DRAWING FOR GRAPHIC CLARITY. ALL VALVE BOXES AND EQUIPMENT VAULTS SHALL BE LOCATED IN MULCH BEDS.

GAL GALLON CONTAINER

CODE

QUEP

CODE

AZGT

DIST

**ILEB** 

OSMF

CODE

LIRS

2,876 sf

MS MULTI-STEMMED TRUNK

BOTANICAL / COMMON NAME

| Quercus phellos / Willow Oak

BOTANICAL / COMMON NAME

| Azalea indica / Indica Azalea

Osmanthus fragrans / Sweet Olive

BOTANICAL / COMMON NAME

| Cynodon dactylon / Bermuda Grass

Distylium x 'PIIDIST-IV' TM / Linebacker Distylium

| Ilex cornuta 'Burfordii Nana' / Dwarf Burford Holly

Liriope muscari 'Super Blue' / Super Blue Lilyturf

Thuja occidentalis 'Smaragd' / Emerald Green Arborvitae

CAL TRUNK CALIPER

FWF FULL WELL FORMED

**TREES** 

**SHRUBS** 

₹ • ⊱

£3

**GROUND COVERS** 

SPECIMEN MATERIAL

TREE FORM HABIT

EGG EGG CAN CONTAINER B&B BALLED AND BURLAPPED MATERIAL

CON CONTAINERIZED MATERIAL

BR BARE ROOT MATERIAL ESP ESPALIER

HEIGHT

12`-14`

**HEIGHT** 

18"-24"

4`-5`

**HEIGHT** 

SPACING

18" o.c.

SIZE

SIZE

7 GAL

3 GAL

3 GAL

7 GAL

SIZE

4" POT

SOD

2.5" CAL

FWF. SP. CLEAR TRUNK TO 6'

REMARKS

**REMARKS** 

FWF, SP, CON

FWF, SP, CON

FWF, SP, CON

FWF, SP, CON

REMARKS

FWF, SP, CON

TIF 419 OR EQUAL

FWF, SP, FULL TO GROUND

MOUNT PLEASANT, SC 843.884.1667 GREENVILLE, SC 864.298.0534 SUMMERVILLE, SC 843.972.0710 SPARTANBURG, SC 864.272.1272 CHARLOTTE, NC 980.312.5450 WWW.SEAMONWHITESIDE.COM

SEAMON, WHITESIDE & ASSOCIATES, INC

0

SW+ PROJECT: GR3904 01/13/2022 DRAWN BY: CHECKED BY:

PLANT

NO IRRIGATION COMPONENTS, INCLUDING BUT NOT

BE INSTALLED WITHIN DEPARTMENT OF

TRANSPORTATION RIGHT-OF-WAY.

LIMITED TO, VALVE BOXES, CONTROL BOXES, BACKFLOW

PREVENTERS, AND/OR RAIN SENSORS ARE ALLOWED TO

PLANT SCHEDULE

NOTES

**REVISION HISTORY** 

SCHEDULE & **DETAILS** 

**Neighborhood Meeting** 

Project Name: SOTERIA HOUSING

Location: VIRTUAL, Via Microsoft Teams

Time of the meeting: 6 pm

Date: Thursday, January 13, 2022

Representative holding meeting: Luke W. Perry, Johnston Design Group

Nar	ne	Street Address	Email	
1	John (Anonymous)			
2	Linda and William Harkins	102 Conyers St. Greenville, SC	lucyandbill12@gmail.com	
3	Kirsten Meier	325 Shaw St. Greenville, SC 29609	meieruk@gmail.com	
4	Slowik Household	160 Stall Street	did not provide	
5	Gary Davis	1116 S. Main Street, Greenville, SC 29601	gary.davis@captrust.com	
6	Jerry Blassingame	201 Shaw St. Greenville, SC 29609	jblassingame@soteriacdc.org	
7	Luke W. Perry	101 Alpine Way, Greenville, SC 29609	luke@johnstondesign.group	
8	Paul Dow	COG Engineering		
9	Rebecca Edwards	COG Community Development		
10	Austin Rutherford	COG Planning		
11				
12	•	64-422-8045) called me to learn more about the project. S	he was mainly curious,	
13	but said "sounds like a good project."			
14				
15				
16				
17				
18				
19				
20				
21				
22				
23				
24				
25				